



May 2, 2024,

23-75

Katherine Cook  
Planning Coordinator  
City of Auburn  
60 Court Street  
Auburn, ME 04210

**Subject: 80 Lake Street  
Response to Comment Letter**

Dear Katherine,

On behalf of Jim Wu, Terradyn Consultants, LLC is pleased to submit responses to staff comments on the Site Plan application for the 80 Lake Street project. The information enclosed was prepared in response to the staff review comments provided on April 12, 2024.

## **Comment Responses**

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The following responses to comments are from the information provided. The original comments are in *Italics*:

### **Comments from Katherine Cook, Planning Coordinator, Dated April 12, 2024:**

1. *All roof drains tied into the sewer must be removed.*

**Comment Response:** The roof drains that currently tie in the sanitary sewer will be separated as part of the proposed development; please see the attached plans for additional information.

2. *Are you still planning on including the playground as part of the project? You will need to submit information on the playground equipment as part of the permit application.*

**Comment Response:** The applicant still intends to install a playground as part of the proposed project; additional information regarding the playground is attached to this letter.

3. *It appears that the public conservation easement area may be a little off from where the City believes it is.*

**Comment Response:** The public conservation easement has been updated to reflect a 200' x 80' easement area on the plans.

4. *We will need to see the turning radius movement for the fire apparatus. It is not clear that service vehicles will be able to make the required turning.*

**Comment Response:** An additional turnaround has been added to the plans, fire truck turning templates are attached to this letter.

5. *It appears that with the dumpster's placement, there is no place to push snow. Please address this item.*

**Comment Response:** The dumpster location has been adjusted; additional information is shown on the attached plans.

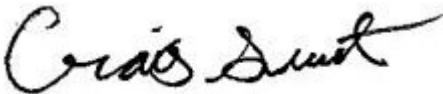
In addition to the response to the comments above, we have received confirmation from the Auburn water and sewer district that they have the capacity to serve the redevelopment at 80 Lake Street. A copy of their confirmation is attached.

## CLOSURE

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We trust that the above responses and attached materials address the comments. Please contact me directly with any additional questions or concerns.

Sincerely,  
TERRADYN CONSULTANTS, LLC



Craig Sweet, P.E.

## PLAYGROUND INFORMATION

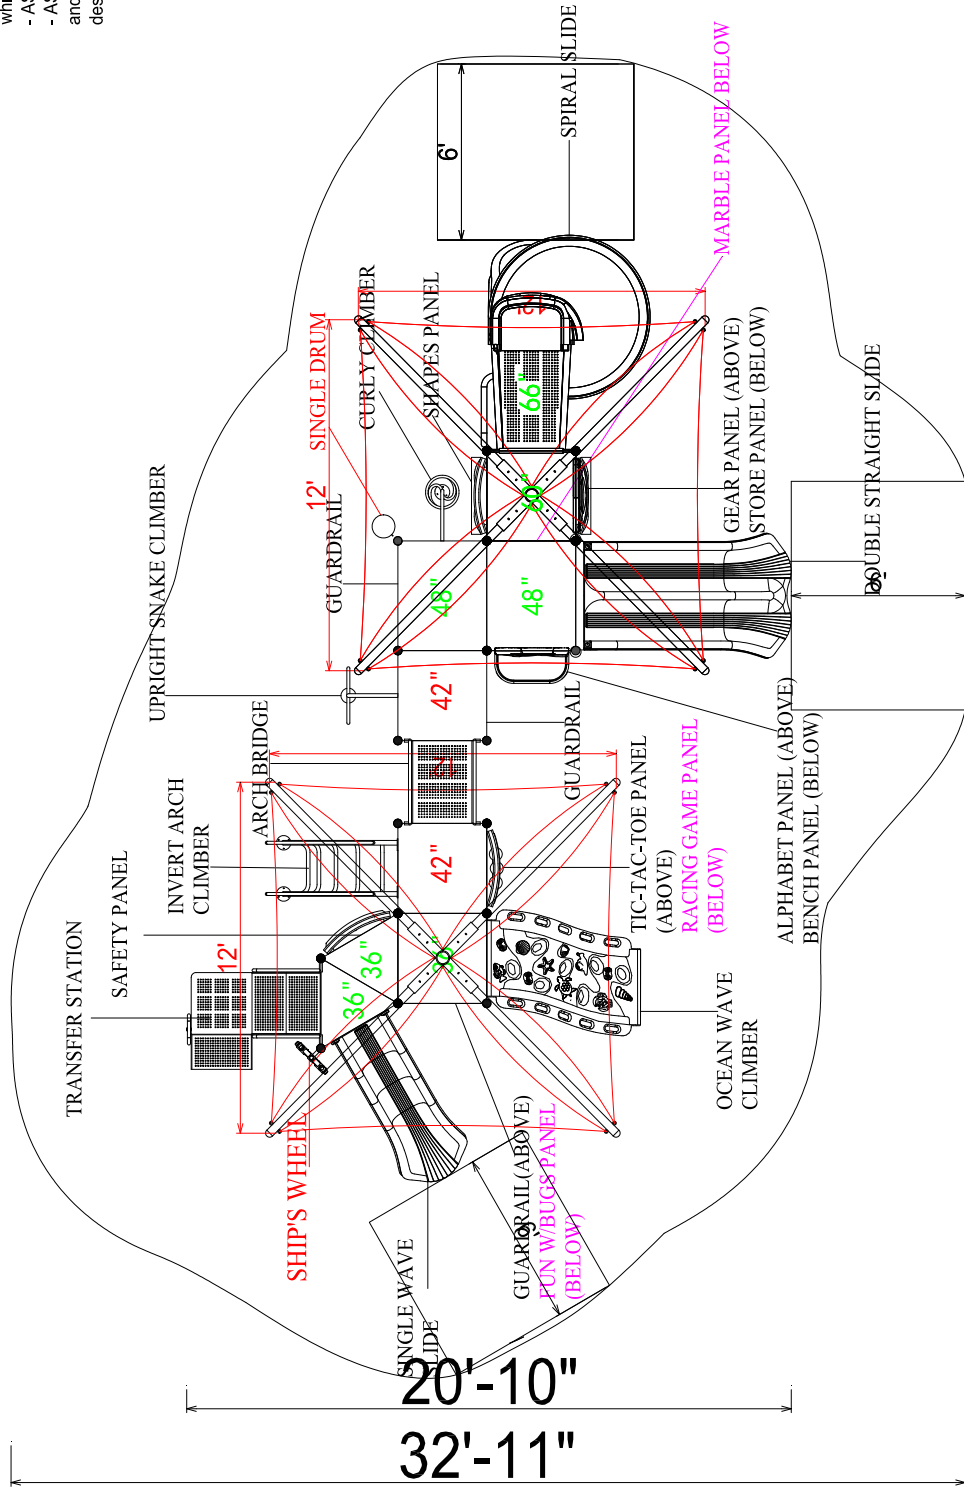
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44'-11"

32'-3"

Compliance:  
 This play structure has been designed to meet the safety requirements established in:  
 - 2010 ADA Standard  
 - ASTM F1487  
 - CPSC Pub #325  
 when the play structure is installed over a properly maintained surfacing material which is in compliance with:  
 - ASTM F1292  
 - ASTM F1951  
 and is appropriate for the highest designated play surface of the structure.



Drawing No: PGB-34524  
 Date: 14-09-2020  
 Scale: To Fit

Structure Size: 32'-3" x 20'-10" x 15'-11"  
 Recommended Use Zone: 44'-11" x 32'-11"  
 Surface Area: 1485 Sq Ft

HDPS: 5'-6"  
 Age Group: 2-12  
 Capacity: 42-46  
 Weight: 3450 lbs

**Playground Boss - PGB-34524**

**Playground Boss**



44'-11"

32'-3"

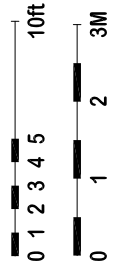
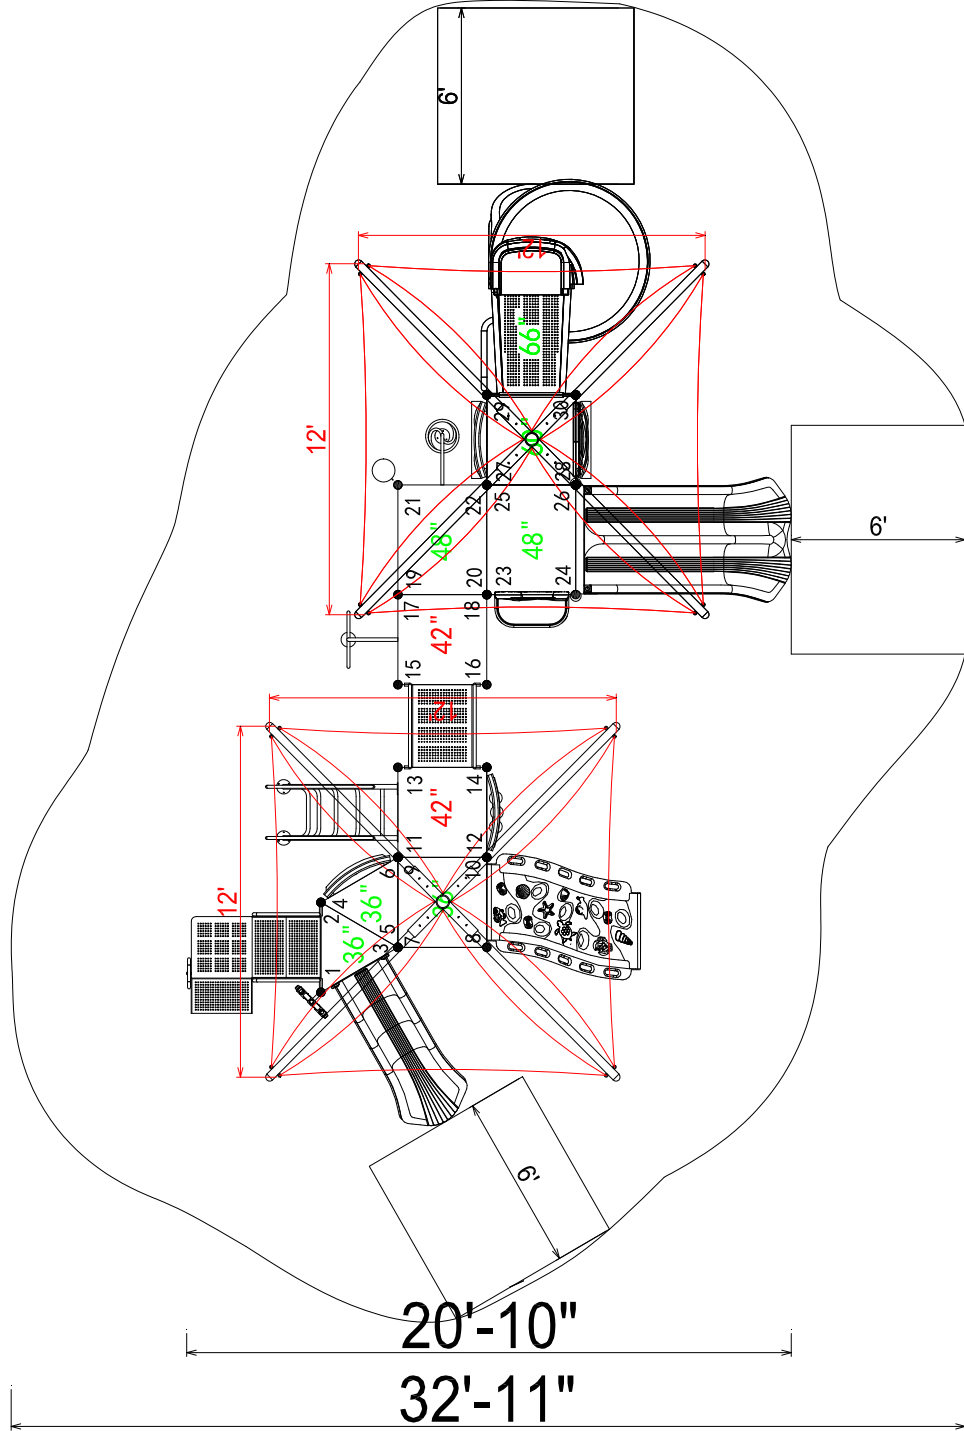
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- ASTM F1487
- CPSC Pub #325

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- ASTM F1292
- ASTM F1951

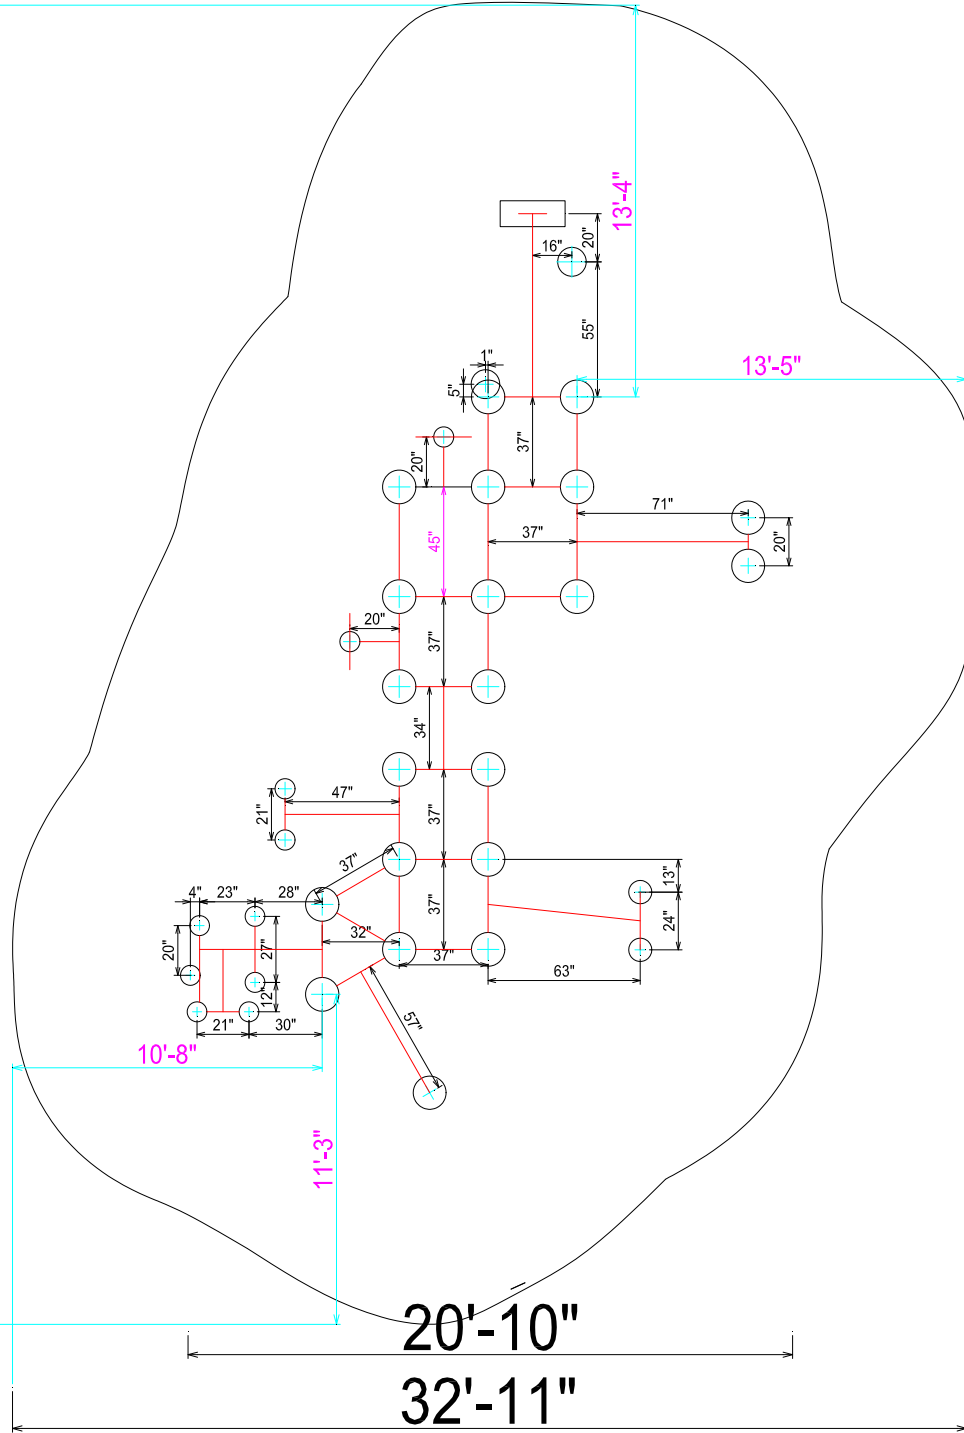
and is appropriate for the highest designated play surface of the structure.



<p><b>Playground Boss - PGB-34524</b></p>	<p>Drawing No: PGB-34524        Date: 14-09-2020        Scale: To Fit</p>		<p>Structure Size: 32'-3" x 20'-10" x 15'-11"        Recommended Use Zone: 44'-11" x 32'-11"        Surface Area: 1485 Sq Ft</p>	<p>Playground Boss</p>
<p>HDPS: 5'-6"        Age Group: 2-12        Capacity: 42-46        Weight: 3450 lbs</p>				

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44'-11"  
 32'-3"



**Playground Boss -  
 PGB-34524**

Drawing No: PGB-34524  
 Date: 14-09-2020  
 Scale: To Fit



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 Surface Area: 1485 Sq Ft

HDPS: 5'-6"  
 Age Group: 2-12  
 Capacity: 42-46  
 Weight: 3450 lbs

**Playground Boss**

## UTILITY CORRESPONDENCE

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## RE: 80 Lake Street Ability To Serve

Mike Broadbent <mbroadbent@awsd.org>

Mon 4/8/2024 8:56 AM

To: Craig Sweet <craig@terradyconsultants.com>

Craig,

The District has sufficient capacity to serve the re-development of 80 Lake Street. The property currently has a 1" domestic meter and 6" sprinkler main. If the meter needs to be upsized you will be responsible for sewer capacity fees and the cost of a new meter.

The last I knew the roof drains at this property are connected to the sewer system, those need to be separated as well.

Mike

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**From:** Craig Sweet <craig@terradyconsultants.com>

**Sent:** Tuesday, April 2, 2024 10:35 AM

**To:** Mike Broadbent <mbroadbent@awsd.org>

**Subject:** 80 Lake Street Ability To Serve

Good Morning Mike,

Our office is working on a proposed development at the Lake Street School Building located at 80 Lake Street to convert the existing building into apartments. We are looking to see if the Water and Sewer Districts have capacity to serve the proposed development from the existing services at the site. Please see our attached letter and draft plan which shows the existing connection locations.

Please let me know if you have any questions or need anything additional information.

Thank you,

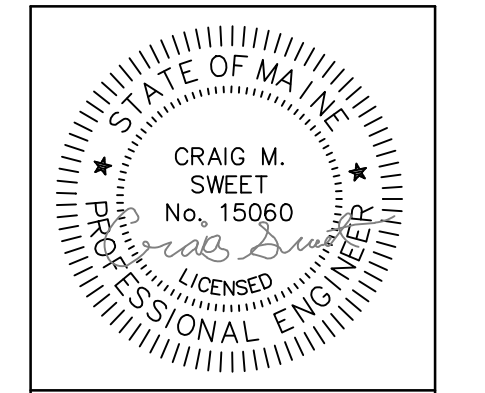
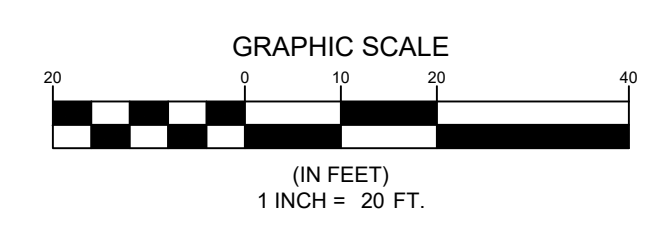
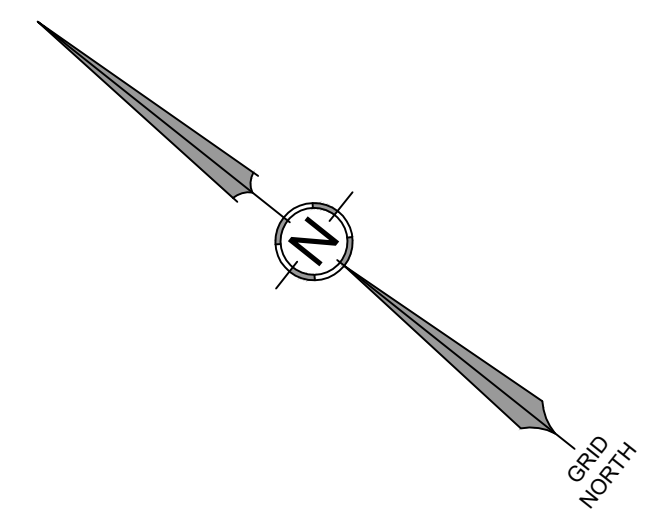
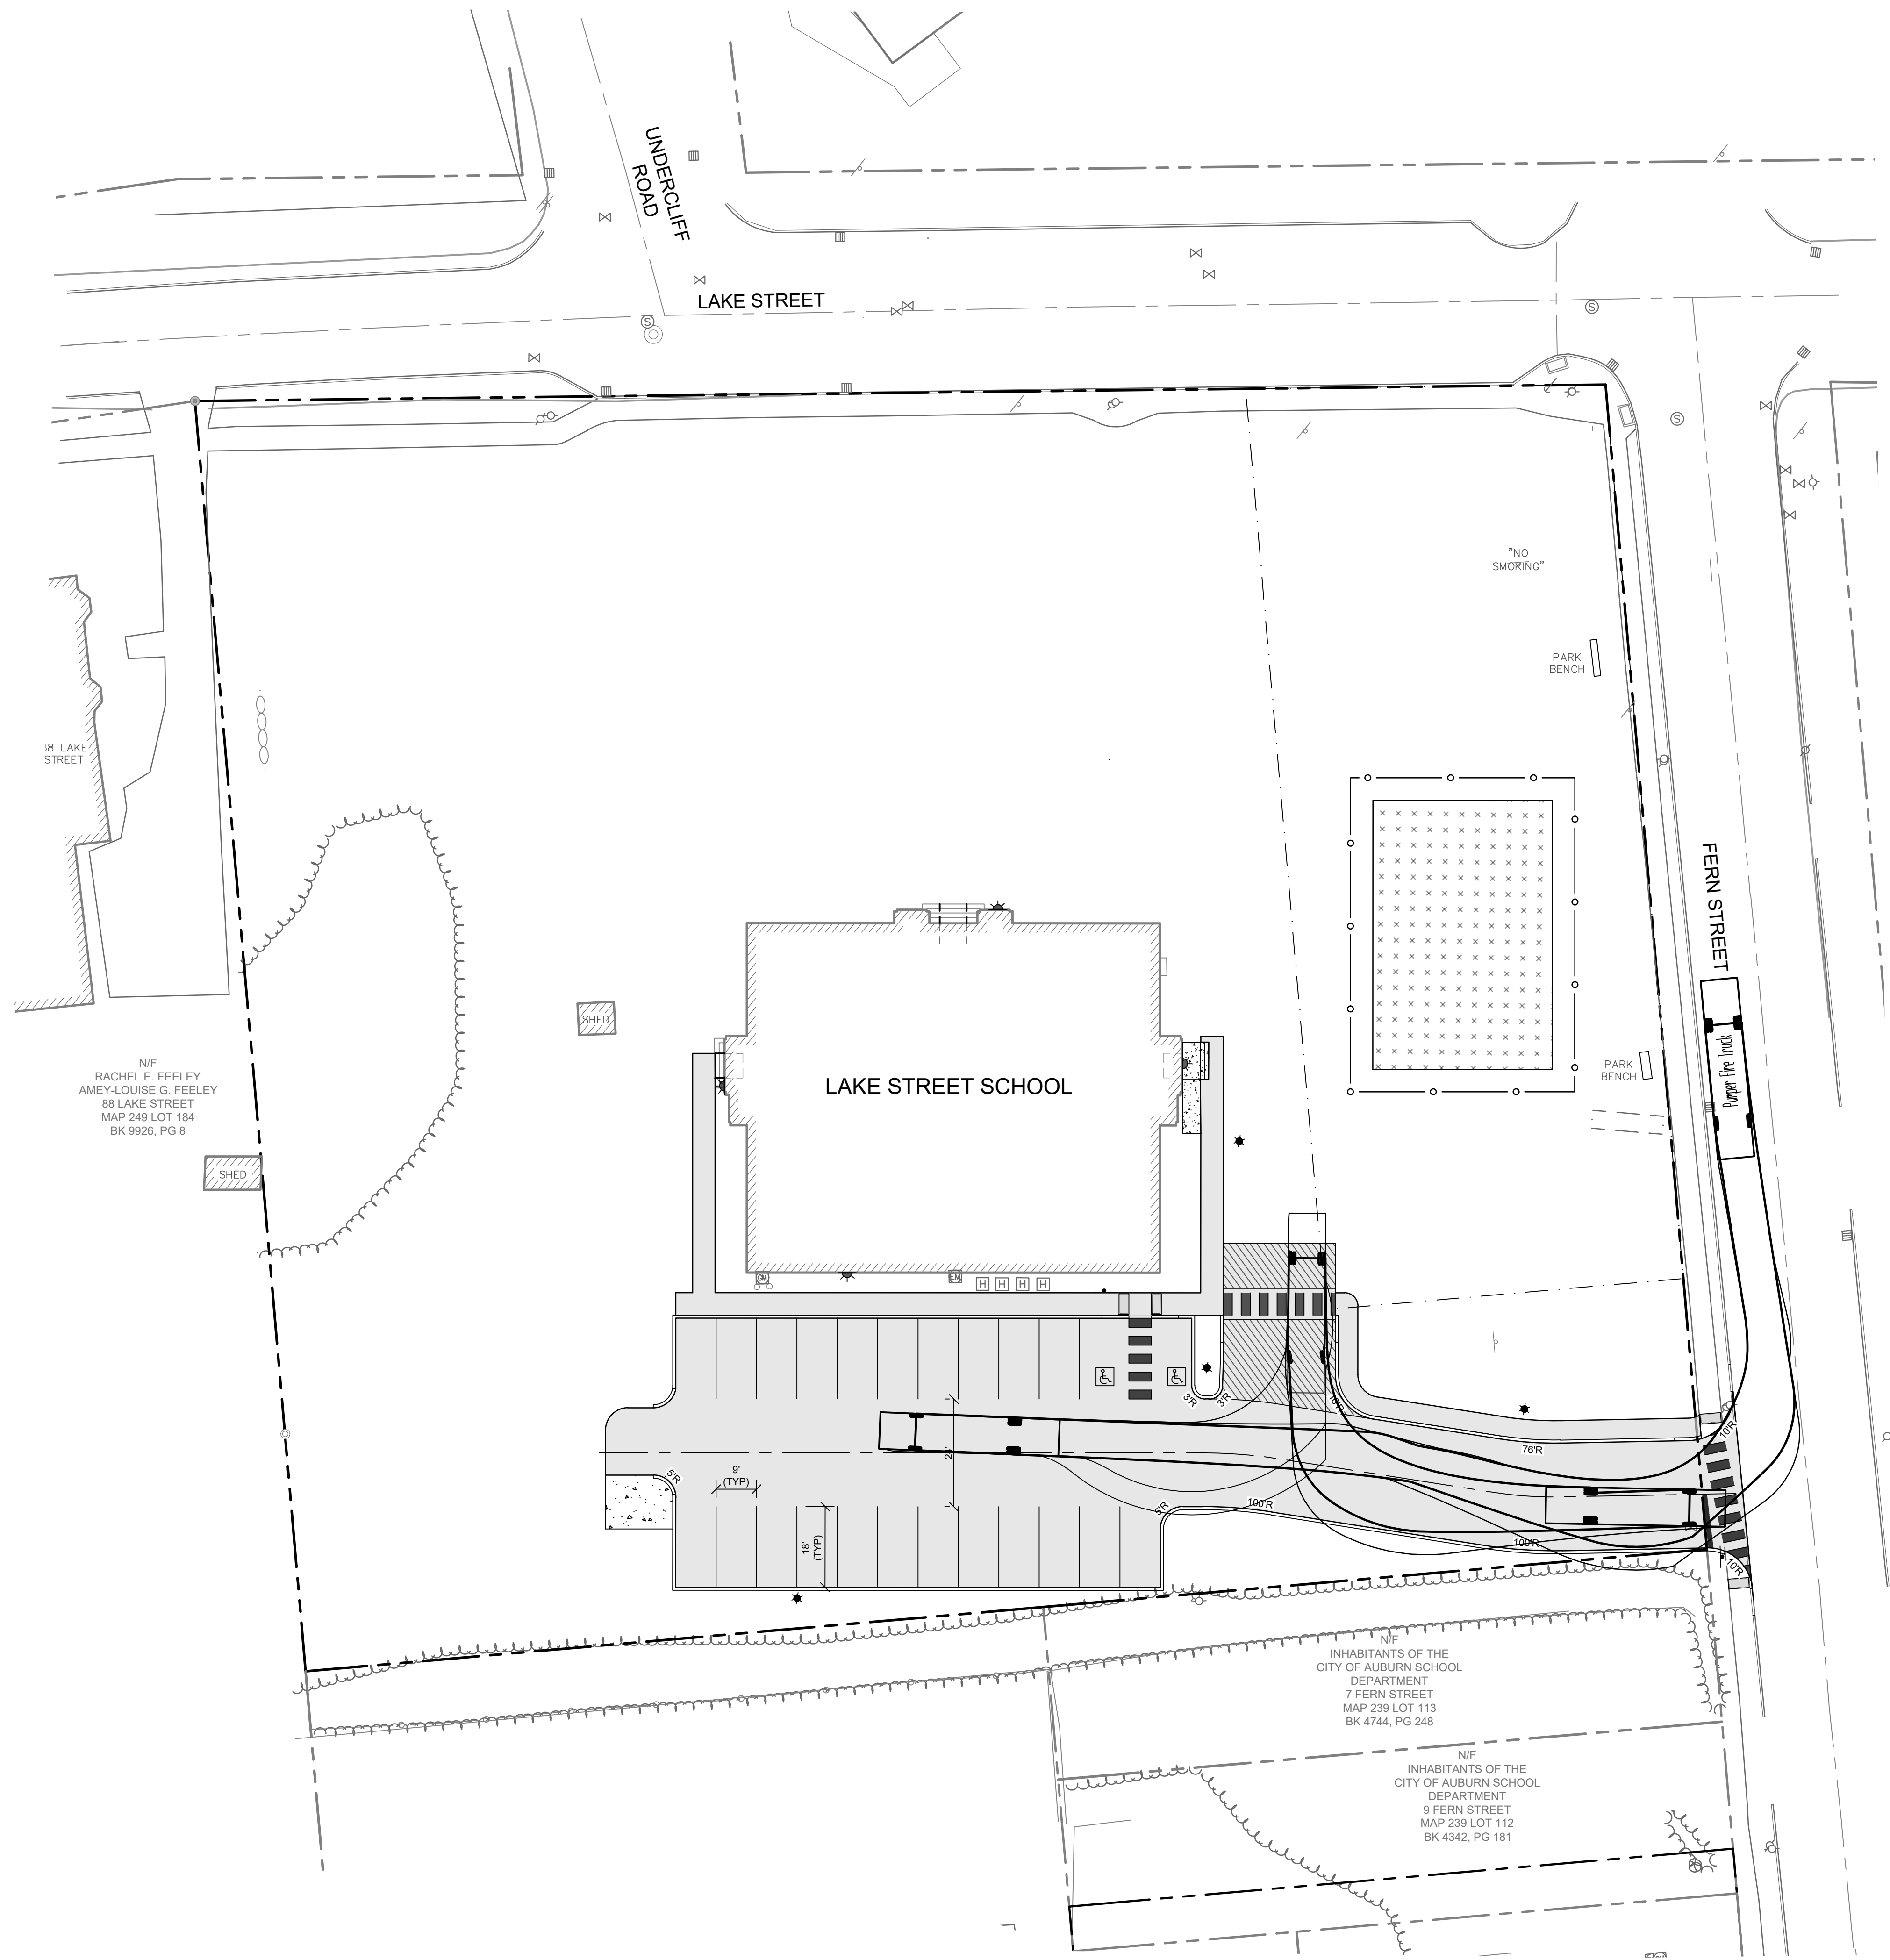
Craig Sweet, P.E.

Terradyn Consultants, LLC

207-370-2776

# FIRE TRUCK TURNING PLAN

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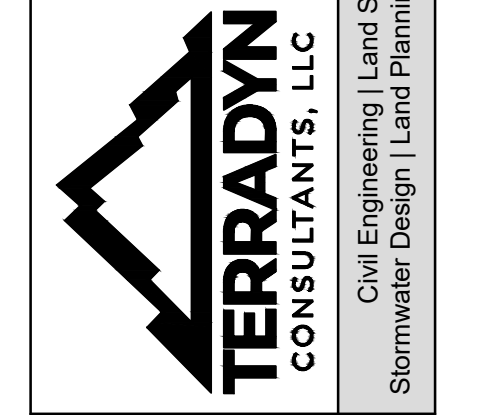


DATE: 4/3/2024

NO	DATE	REVISIONS
1	9/3/2024	FIRE TRUCK ACCESS & PLAYGROUND EASEMENT

NO	DATE	REVISIONS
1	9/3/2024	FIRE TRUCK ACCESS & PLAYGROUND EASEMENT

ADDRESS: 41 CAMPUS DRIVE, SUITE 301  
 NEW GLOUCESTER, ME 04260  
 PHONE: (207) 926-5111  
 WEB SITE: www.terradynconsultants.com



PERMIT DRAWING  
 NOT FOR CONSTRUCTION

PROJECT: LAKE STREET SCHOOL APARTMENTS  
 80 LAKE STREET, AUBURN, MAINE  
 SHEET TITLE: FIRE TRUCK TURNING PLAN  
 CLIENT: JIM WU  
 279 CENTER STREET  
 AUBURN, MAINE 04210  
 DATE: 4/3/2024  
 SCALE: 1"=20'  
 JOB NO: 23-75  
 SHEET: C-2.0

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# REVISED PLANS

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# LAKE STREET SCHOOL APARTMENTS

## AUBURN, MAINE

**PREPARED BY:**

CIVIL ENGINEER/SURVEYOR:  
TERRADYN CONSULTANTS, LLC  
41 CAMPUS DR. SUITE 301  
NEW GLOUCESTER, MAINE 04260  
(207) 926-5111

**APPLICANT:**

JIM WU  
279 CENTER STREET  
AUBURN, MAINE 04210

**OWNER:**

WU LAKE STREET PROPERTIES, LLC  
279 CENTER STREET  
AUBURN, MAINE 04210

**PROJECT PARCEL SITE**

CITY OF AUBURN TAX ASSESSOR'S MAP & LOT NUMBER  
MAP 239 LOT 114

APPROVED: CITY OF AUBURN  
PLANNING BOARD

DATE

**LOCATION MAP**

1" = 200'

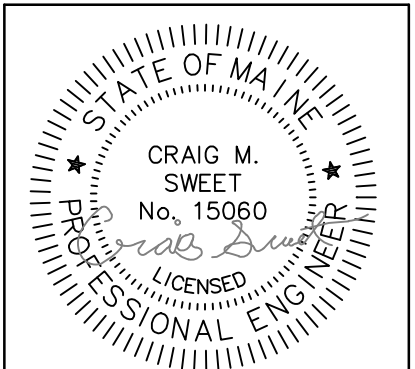


**SHEET INDEX**

C-0.0	COVER SHEET & LOCATION MAP
S-1.0	BOUNDARY RETRACEMENT SURVEY
C-1.0	DEMOLITION PLAN
C-2.0	SITE LAYOUT PLAN
C-3.0	GRADING & UTILITY PLAN
C-5.0	EROSION CONTROL NOTES & DETAILS
C-5.1	SITE DETAILS
C-5.2	SITE DETAILS & NOTES
C-6.0	PHOTOMETRIC PLAN
L-1.0	LANDSCAPING PLAN

**LEGEND**

EXISTING	DESCRIPTION	PROPOSED
---	LOCUS PROPERTY LINE	---
---	PROPERTY LINE	---
---	INTERIOR PROPERTY LINE	---
---	BUFFER LINE	---
---	SETBACK LINE	---
---	EASEMENT LINE	---
---	CENTER LINE	---
---	ZONE LINE	---
□	MONUMENT	□
○	IRON ROD	○
+	STREET / SITE SIGN	+
---	BUILDING	---
---	BUILDING OVERHANG	---
---	BITUMINOUS PAVEMENT	---
---	CURBING	---
---	GRAVEL	---
○	CHAIN LINK FENCE	○
□	STOCKADE FENCE	□
---	STONE WALL	---
---	METAL GUARD RAIL	---
---	WOOD GUARD RAIL	---
---	TREE LINE	---
---	WETLAND AREA	---
---	ROCK OUTCROP	---
+	TEST PIT	+
⊕	MONITORING WELL	⊕
⊖	BORING	⊖
⊙	WELL	⊙
---	MINOR CONTOUR LINE	---
---	MAJOR CONTOUR LINE	---
+	SPOT GRADE	+
---	STORM DRAIN	---
---	UNDER DRAIN	---
---	OVERHEAD UTILITY	---
---	OVERHEAD ELECTRIC	---
---	UNDERGROUND UTILITY	---
---	UNDERGROUND ELECT.	---
---	UNDERGROUND TEL.	---
□	TRANSFORMER	□
○	UTILITY POLE	○
---	GUY WIRE	---
---	SILT FENCE	---
---	FILTER BARRIER	---
---	MULCH BERM	---
---	SILT BARRIER	---
---	RIPRAP	---
---	WETLAND ALTERATION AREA	---



DATE: 4/3/2024

1	5/3/2024	DATE
1		NO.
		REVISIONS
		FIRE TRUCK ACCESS & PLAYGROUND EASEMENT

ADDRESS: 41 CAMPUS DRIVE, SUITE 301  
NEW GLOUCESTER, ME 04260  
PHONE: (207) 926-5111  
WEB SITE: www.terradynconsultants.com

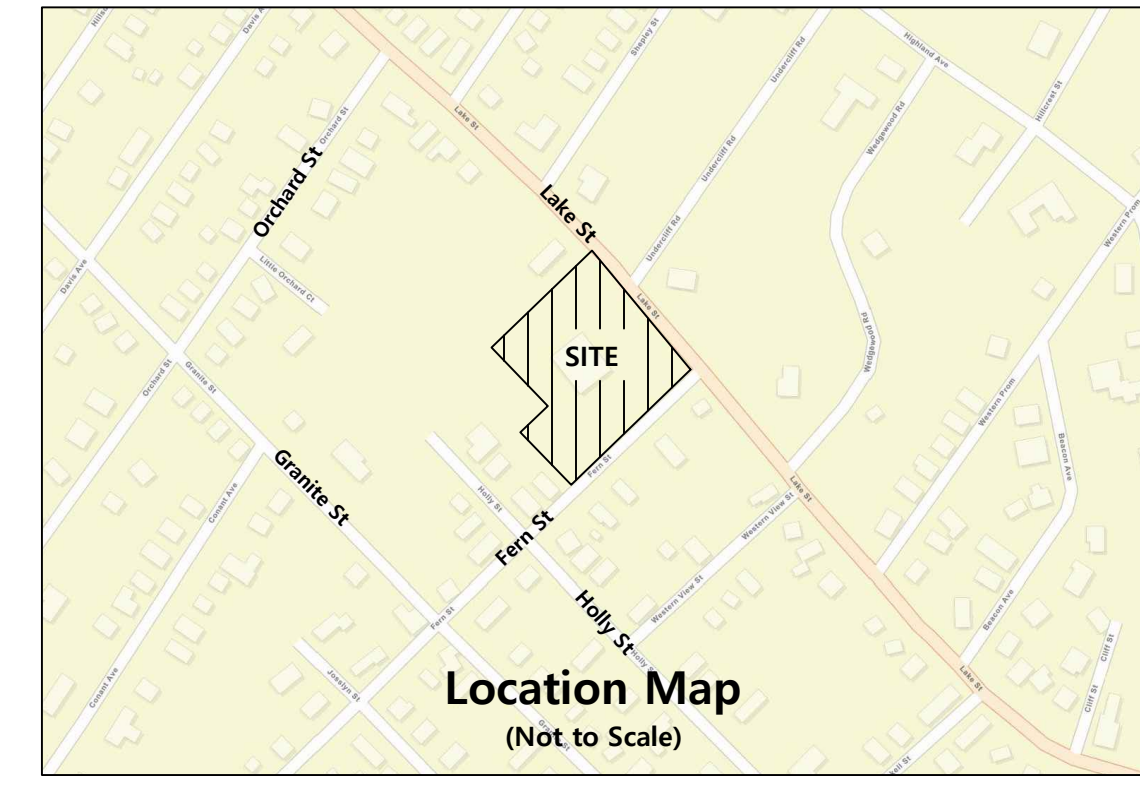
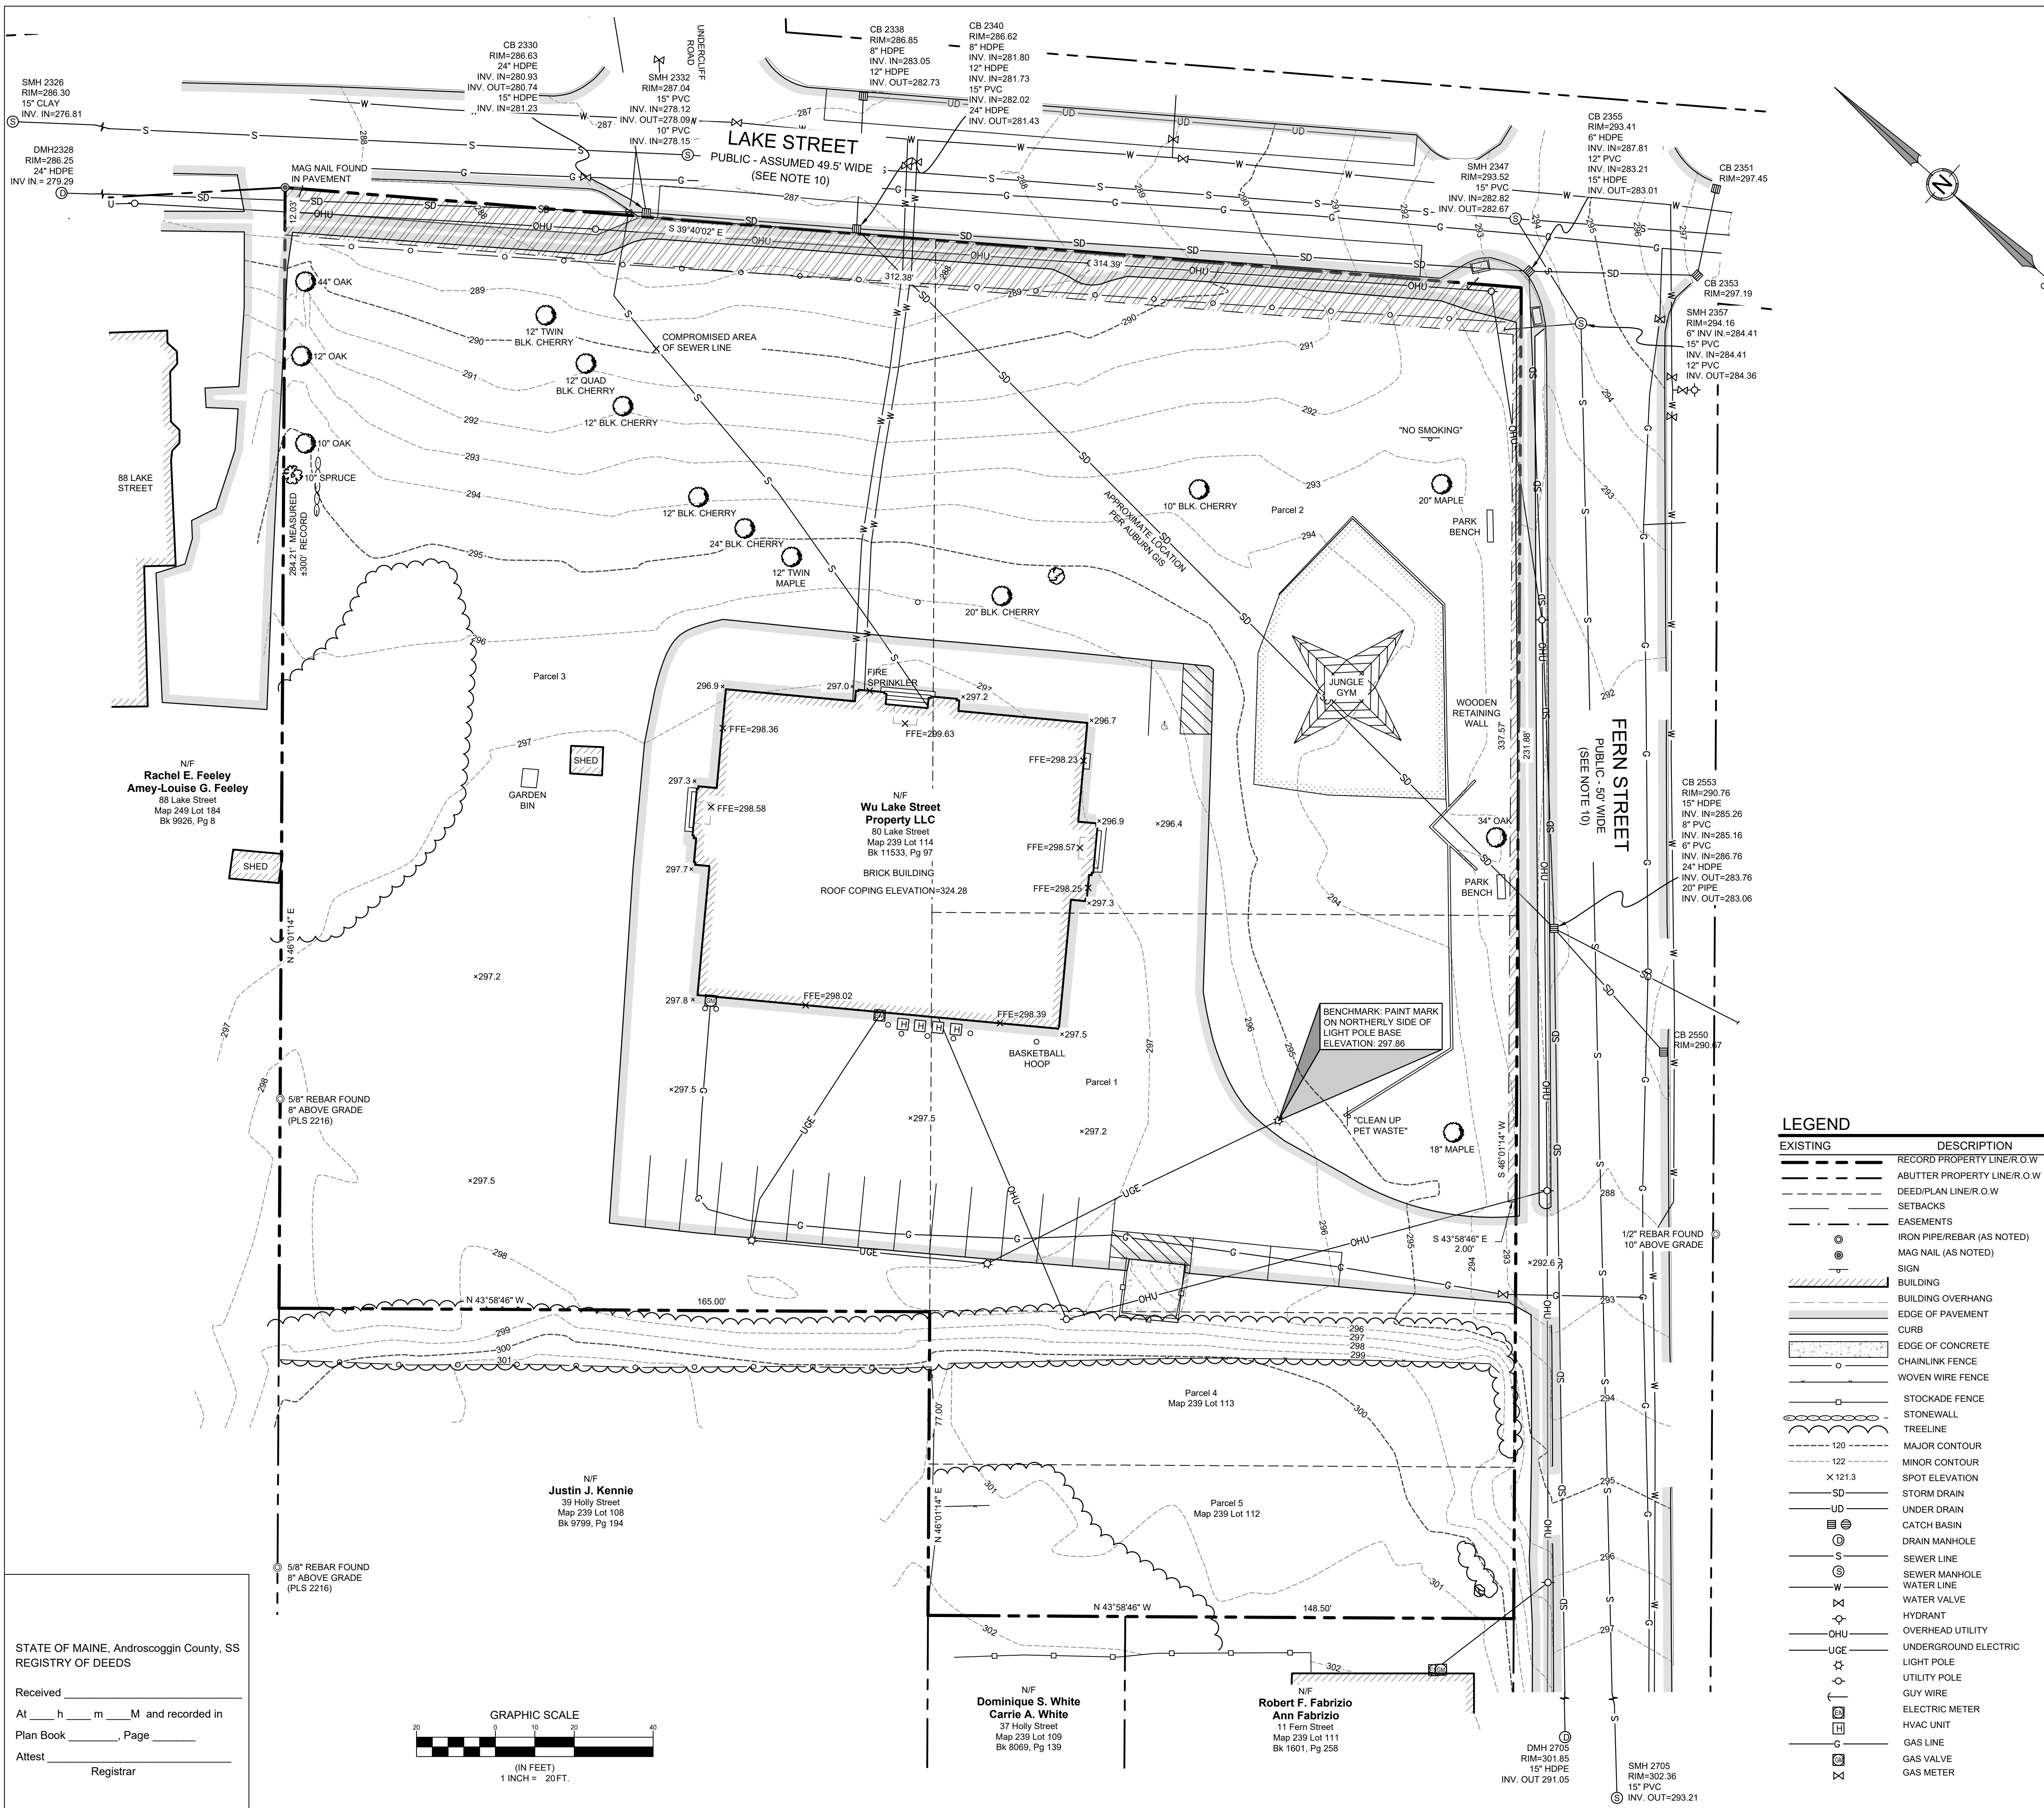
TERRADYN CONSULTANTS, LLC  
Civil Engineering | Land Surveying | Geomatics  
Stormwater Design | Land Planning | Environmental Permitting

PERMIT DRAWING  
NOT FOR CONSTRUCTION

PROJECT: LAKE STREET SCHOOL APARTMENTS  
SHEET TITLE: COVER & LOCATION MAP  
CLIENT: JIM WU  
279 CENTER STREET  
AUBURN, MAINE 04210

DATE: 4/3/2024  
SCALE: 1"=200'  
JOB NO: 23-75  
SHEET: C-0.0

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- General Notes:**
- The purpose of this plan is to depict the results of a Boundary Retracement Survey and an Existing Conditions/Topographic Survey of the subject parcels.
  - All Book and Page numbers refer to the Androscoggin County Registry of Deeds, unless otherwise noted.
  - The record owner of the subject parcel is Wu Lake Street Properties LLC by a deed dated February 20, 2024 and recorded as Book 11533, Page 97.
  - The subject parcel is shown on the City of Auburn Tax Map 239 as Lots 112, 113, and 114 and is located in the Traditional Neighborhood District (T-4.2B).
  - Space and bulk standards for the T-4.2B District as of the date of this plan are as follows:
 

Lot Width:	24 ft. min./120 ft. max.
Frontage Build-Out:	60% min (along front setback, primary)
Front Setback:	5 ft. min./25 ft. max.
Side Setback:	5 ft. min.
Rear Setback:	10 ft. min.
Building Height:	1 story min./3 story max.
Building Coverage:	70% max.
  - Total area of the subject parcel is 2.223 acres.
  - Boundary and topographic information shown hereon is based on an on-the-ground survey performed by TerradyN Consultants, LLC in November and December of 2023.
  - Plan References:
    - "Plan of the Homestead of Isaiah Haskell" dated May 16, 1863, prepared by Rufus Prince, and recorded in Volume 1, Book 1, Page 10.
  - Plan orientation is Grid North, Maine State Plane Coordinate System, West Zone 1802-NAD83. Elevations depicted hereon are NAVD88, based on dual-frequency GPS observations.
  - Lake Street is assumed to be 3 rods (49.5') wide and the location is based on monumentation found. Fern Street is 50' wide as defined by the City of Auburn Street Records.
  - The subject parcel is located within Zone X, Areas of Minimal Flood Hazard, as delineated on the Flood Insurance Rate Map for the City of Auburn, Androscoggin County, Community-Panel Number 23001C0326E, having an Effective Date of July 8, 2013.
  - Underground utilities depicted hereon were marked by ProMark Utility Locating, Inc. on November 28, 2023 may not necessarily represent all existing utilities on the subject parcel. Owners, contractors, and/or designers need to contact Dig-Safe Systems, Inc. (call 811) and field verify existing utilities prior to digging or breaking ground.
  - Tax Map 239, Lot 12 & 13 are subject to the use of a driveway running in a northerly direction to the northwest corner of the cottage house. No driveway found and no cottage exists on the premises. Rights may be extinguished.

**LEGEND**

EXISTING	DESCRIPTION
---	RECORD PROPERTY LINE/R.O.W
---	ABUTTER PROPERTY LINE/R.O.W
---	DEED/PLAN LINE/R.O.W
---	SETBACKS
---	EASEMENTS
⊙	IRON PIPE/REBAR (AS NOTED)
⊙	MAG NAIL (AS NOTED)
⊙	SIGN
▭	BUILDING
▭	BUILDING OVERHANG
▭	EDGE OF PAVEMENT
▭	CURB
▭	EDGE OF CONCRETE
▭	CHAINLINK FENCE
▭	WOVEN WIRE FENCE
▭	STOCKADE FENCE
▭	STONEWALL
▭	TREELINE
---	MAJOR CONTOUR
---	MINOR CONTOUR
X 121.3	SPOT ELEVATION
SD	STORM DRAIN
UD	UNDER DRAIN
⊙	CATCH BASIN
⊙	DRAIN MANHOLE
S	SEWER LINE
⊙	SEWER MANHOLE
W	WATER LINE
W	WATER VALVE
OHU	HYDRANT
OHU	OVERHEAD UTILITY
UGE	UNDERGROUND ELECTRIC
⊙	LIGHT POLE
⊙	UTILITY POLE
⊙	GUY WIRE
⊙	ELECTRIC METER
⊙	HVAC UNIT
⊙	GAS LINE
⊙	GAS VALVE
⊙	GAS METER

**Surveyor's Certification**

To the best of my knowledge, I have used ordinary and prudent conduct expected of Professional Land Surveyors and the results shown here represent the licensee's responsibility to the public as required under the Standards of Practice as defined by the Board of Licensure for Professional Land Surveyors (M.R.S.A Title 32, Chapter 141, Dated April 2001).

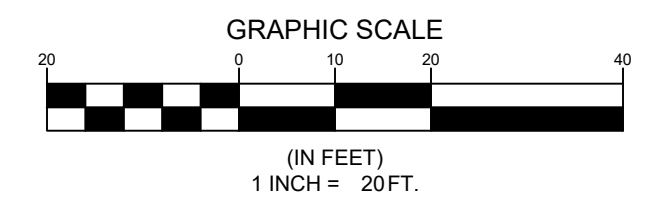
Except as Follows:

- Survey Report Limited to Notes on the Plan
- No Deed Description to Date
- Survey monuments not set

Plan Prepared by: *Nicholas Racioppi*  
Nicholas Racioppi PLS # 2621

STATE OF MAINE, Androscoggin County, SS  
REGISTRY OF DEEDS

Received \_\_\_\_\_  
At \_\_\_\_\_ h \_\_\_\_\_ m \_\_\_\_\_ M and recorded in  
Plan Book \_\_\_\_\_ Page \_\_\_\_\_  
Attest \_\_\_\_\_  
Registrar



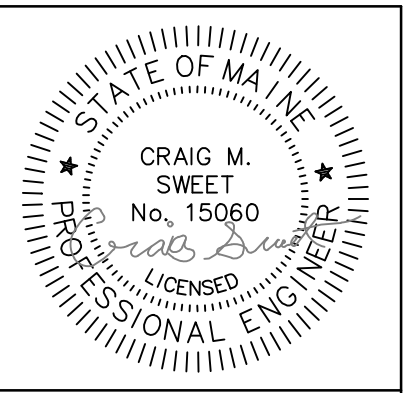
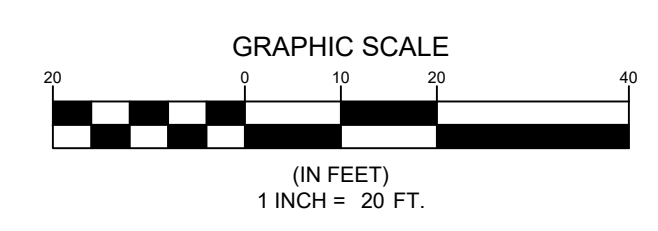
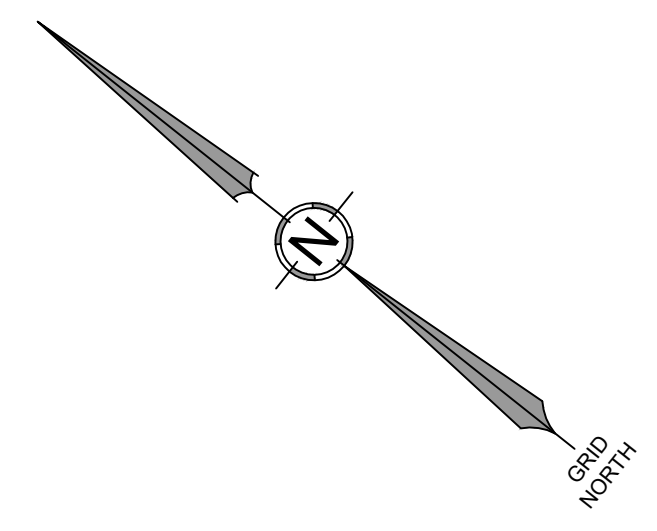
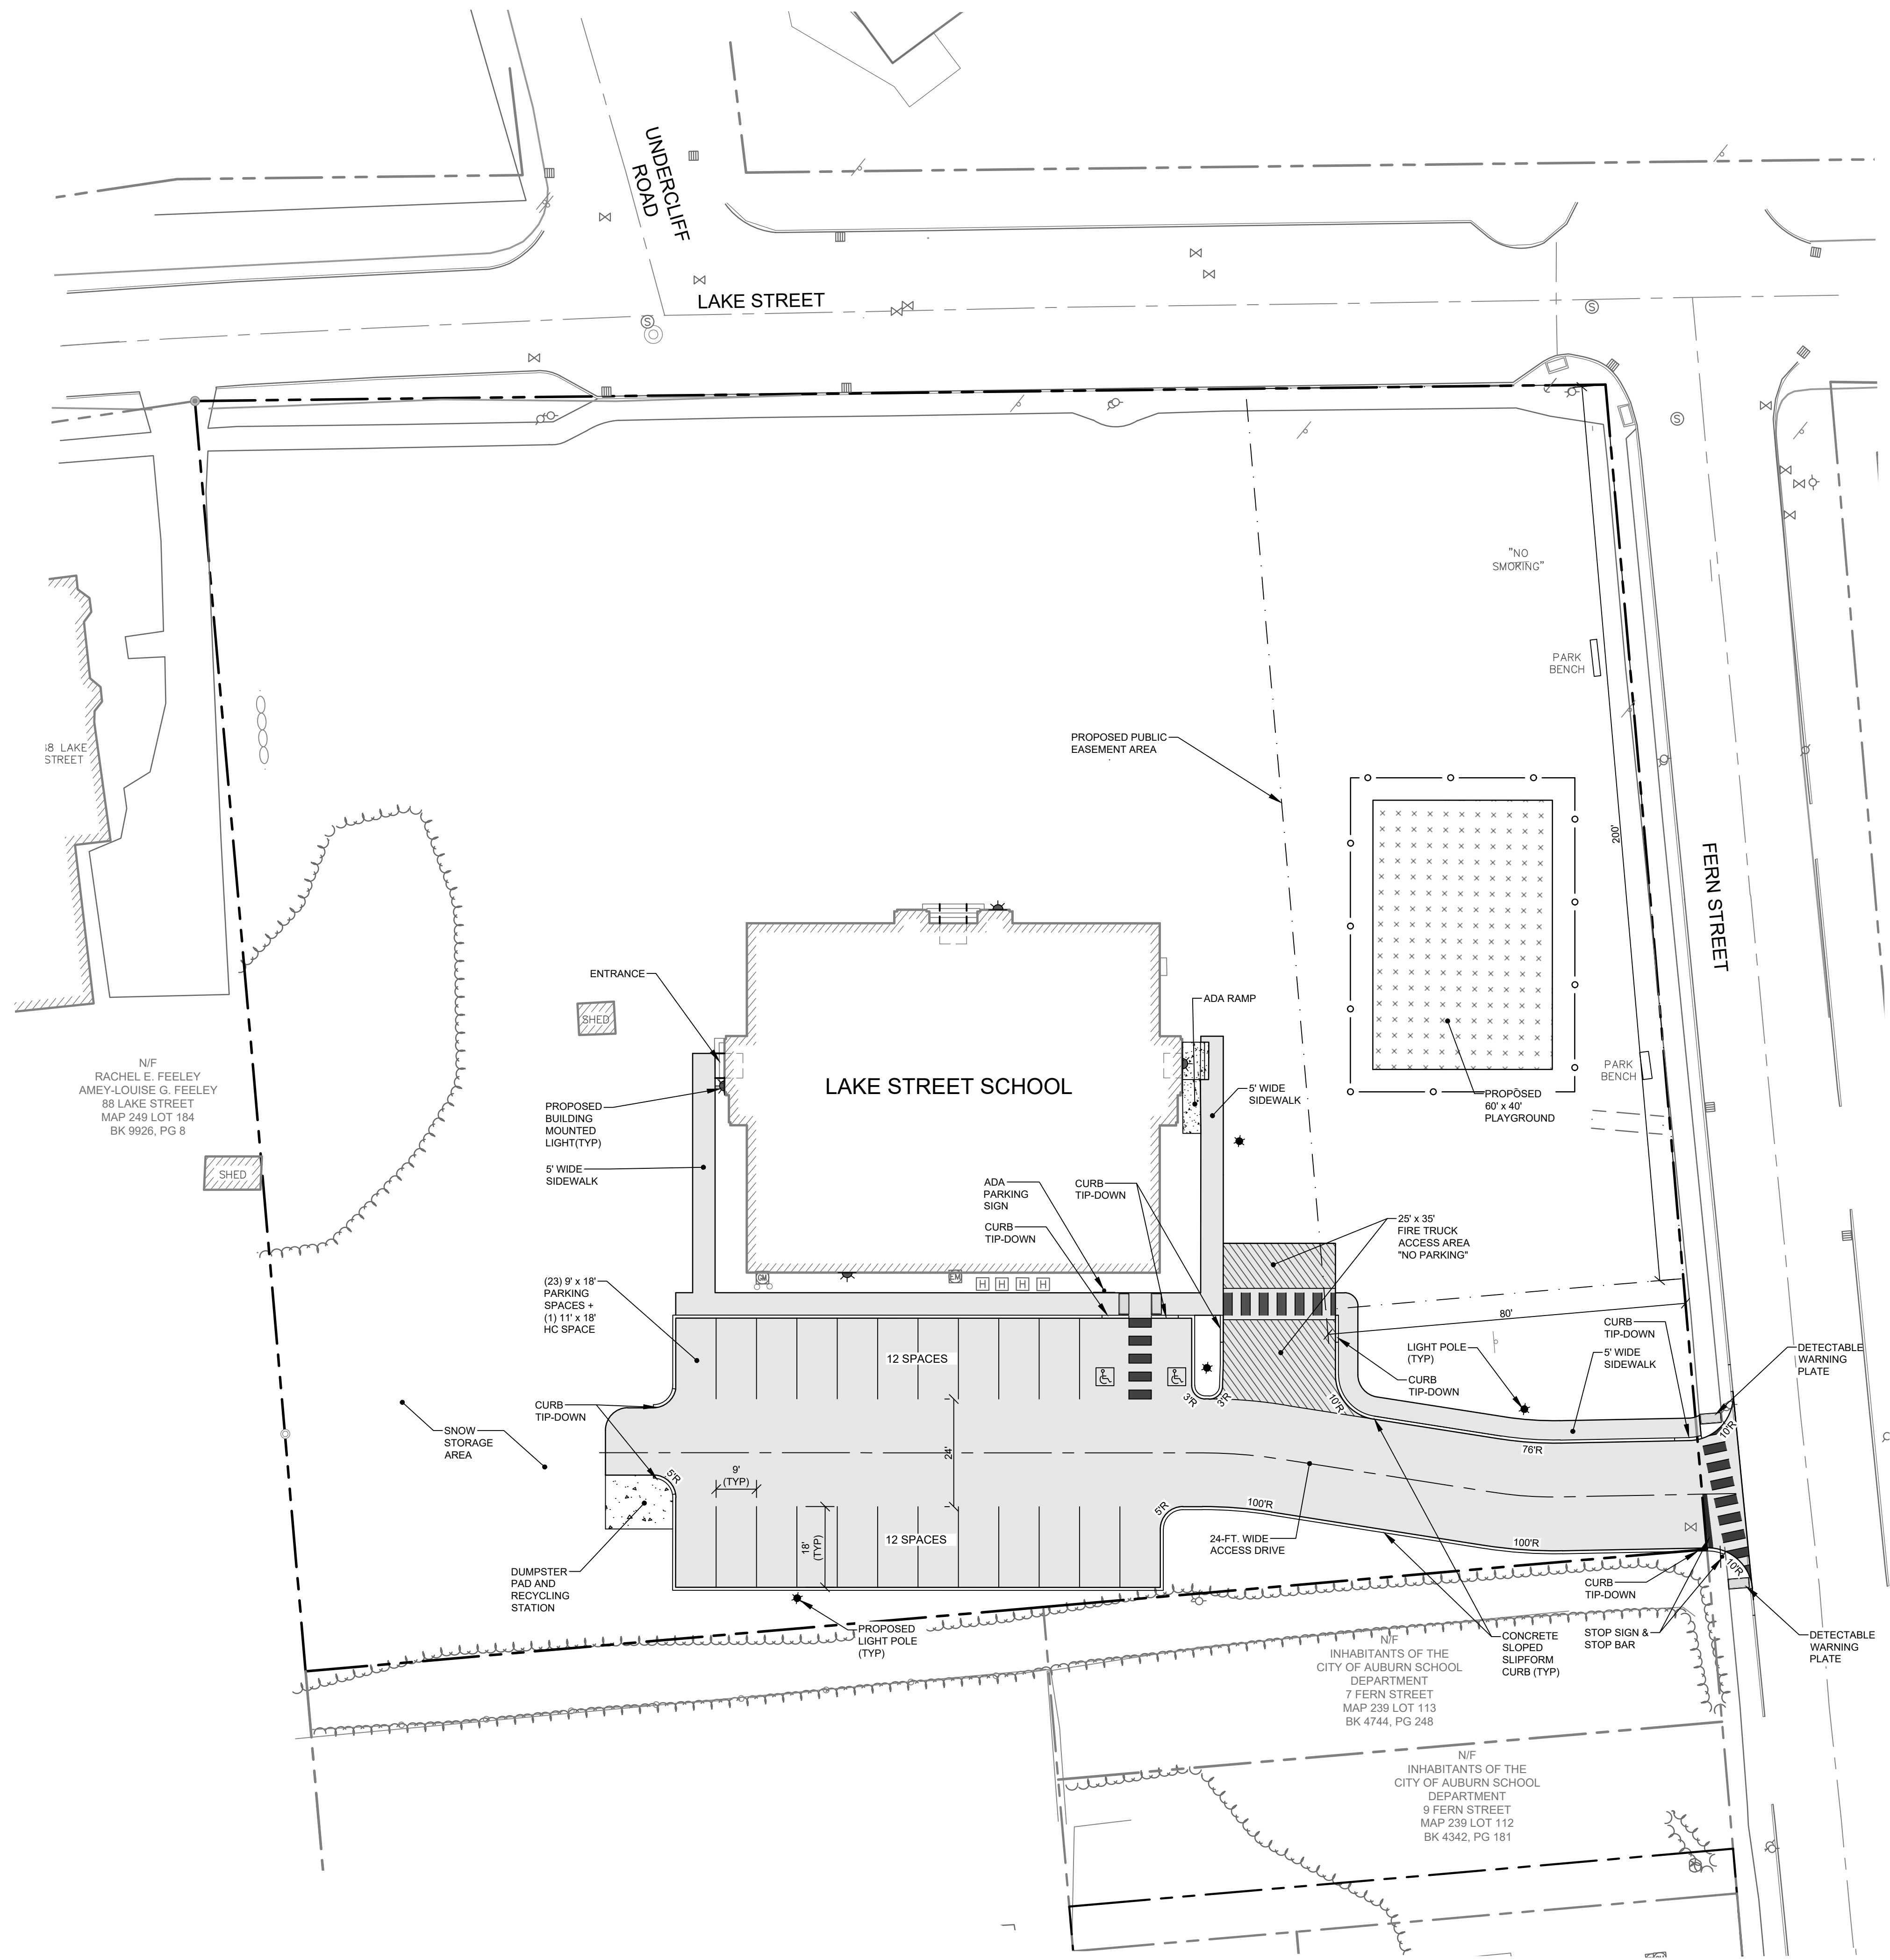
PROJECT: <b>LAKE STREET SCHOOL</b> 80 LAKE STREET, AUBURN, MAINE	ADDRESS: 41 CAMPUS DRIVE, SUITE 301 NEW GLOUCESTER, ME 04260	DATE: 12/05/2023	NO. 1	ISSUE TO CLIENT FOR REVIEW
SHEET TITLE: <b>BOUNDARY RETRACEMENT SURVEY &amp; EXISTING CONDITIONS/TOPOGRAPHIC SURVEY</b>	PHONE: (207) 926-5111	DATE	NO.	REVISIONS
PREPARED FOR RECORD OWNER: <b>WU LAKE STREET PROPERTY LLC</b> 279 CENTER STREET AUBURN, MAINE 04210	WEB SITE: www.terradyncs.com	DATE	NO.	REVISIONS
Civil Engineering   Land Surveying   Geomatics Stormwater Design   Land Planning   Environmental Permitting				
TERRADYN CONSULTANTS, LLC				
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**GENERAL NOTES:**

- THE RECORD OWNER OF THE SUBJECT PARCEL IS WU LAKE STREET PROPERTIES LLC BY A DEED DATED FEBRUARY 20, 2024 AND RECORDED AS BOOK 11533, PAGE 97
- THE SUBJECT PARCEL IS SHOWN ON THE CITY OF AUBURN TAX MAP 239 AS LOTS 112, 113, AND 114 AND IS LOCATED IN THE TRADITIONAL NEIGHBORHOOD DISTRICT (T-4.2B).
- SPACE AND BULK STANDARDS FOR THE T-4.2B DISTRICT AS OF THE DATE OF THIS PLAN ARE AS FOLLOWS:
 

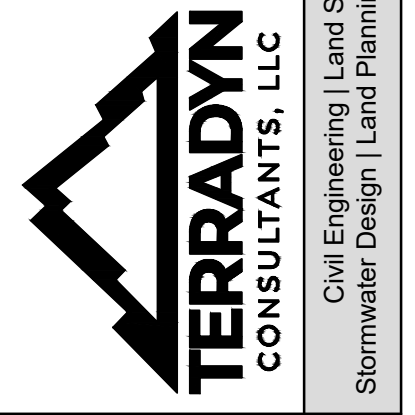
LOT WIDTH:	24 FT. MIN./120 FT. MAX.
FRONTAGE BUILD-OUT:	60% MIN (ALONG FRONT SETBACK, PRIMARY)
FRONT SETBACK:	5 FT. MIN./25 FT. MAX.
SIDE SETBACK:	5 FT. MIN.
REAR SETBACK:	10 FT. MIN.
BUILDING HEIGHT:	1 STORY MIN./3 STORY MAX.
BUILDING COVERAGE:	70% MAX.
- TOTAL AREA OF THE SUBJECT PARCEL IS 2.223 ACRES.
- BOUNDARY AND TOPOGRAPHIC INFORMATION SHOWN HEREON IS BASED ON AN ON-THE-GROUND SURVEY PERFORMED BY TERRADYN CONSULTANTS, LLC IN NOVEMBER AND DECEMBER OF 2023.
- PLAN REFERENCES:
  - "PLAN OF THE HOMESTEAD OF ISAAH HASKELL" DATED MAY 16, 1863, PREPARED BY RUFUS PRINCE, AND RECORDED IN VOLUME 1, BOOK 1, PAGE 10.
- PLAN ORIENTATION IS GRID NORTH, MAINE STATE PLANE COORDINATE SYSTEM, WEST ZONE 1802-NAD83. ELEVATIONS DEPICTED HEREON ARE NAVD89, BASED ON DUAL-FREQUENCY GPS OBSERVATIONS.
- THE SUBJECT PARCEL IS LOCATED WITHIN ZONE X, AREAS OF MINIMAL FLOOD HAZARD, AS DELINEATED ON THE FLOOD INSURANCE RATE MAP FOR THE CITY OF AUBURN, ANDROSCOGGIN COUNTY, COMMUNITY-PANEL NUMBER 23001C0326E, HAVING AN EFFECTIVE DATE OF JULY 8, 2013.
- UNDERGROUND UTILITIES DEPICTED HEREON WERE MARKED BY PROMARK UTILITY LOCATING, INC. ON NOVEMBER 28, 2023 MAY NOT NECESSARILY REPRESENT ALL EXISTING UTILITIES ON THE SUBJECT PARCEL. OWNERS, CONTRACTORS, AND/OR DESIGNERS NEED TO CONTACT DIG-SAFE SYSTEMS, INC. (CALL 811) AND FIELD VERIFY EXISTING UTILITIES PRIOR TO DIGGING OR BREAKING GROUND.



DATE: 4/3/2024

NO.	DATE	REVISIONS
1	9/3/2024	FIRE TRUCK ACCESS & PLAYGROUND EASEMENT

ADDRESS: 41 CAMPUS DRIVE, SUITE 301  
NEW GLOUCESTER, ME 04260  
PHONE: (207) 926-5111  
WEB SITE: www.terradynconsultants.com

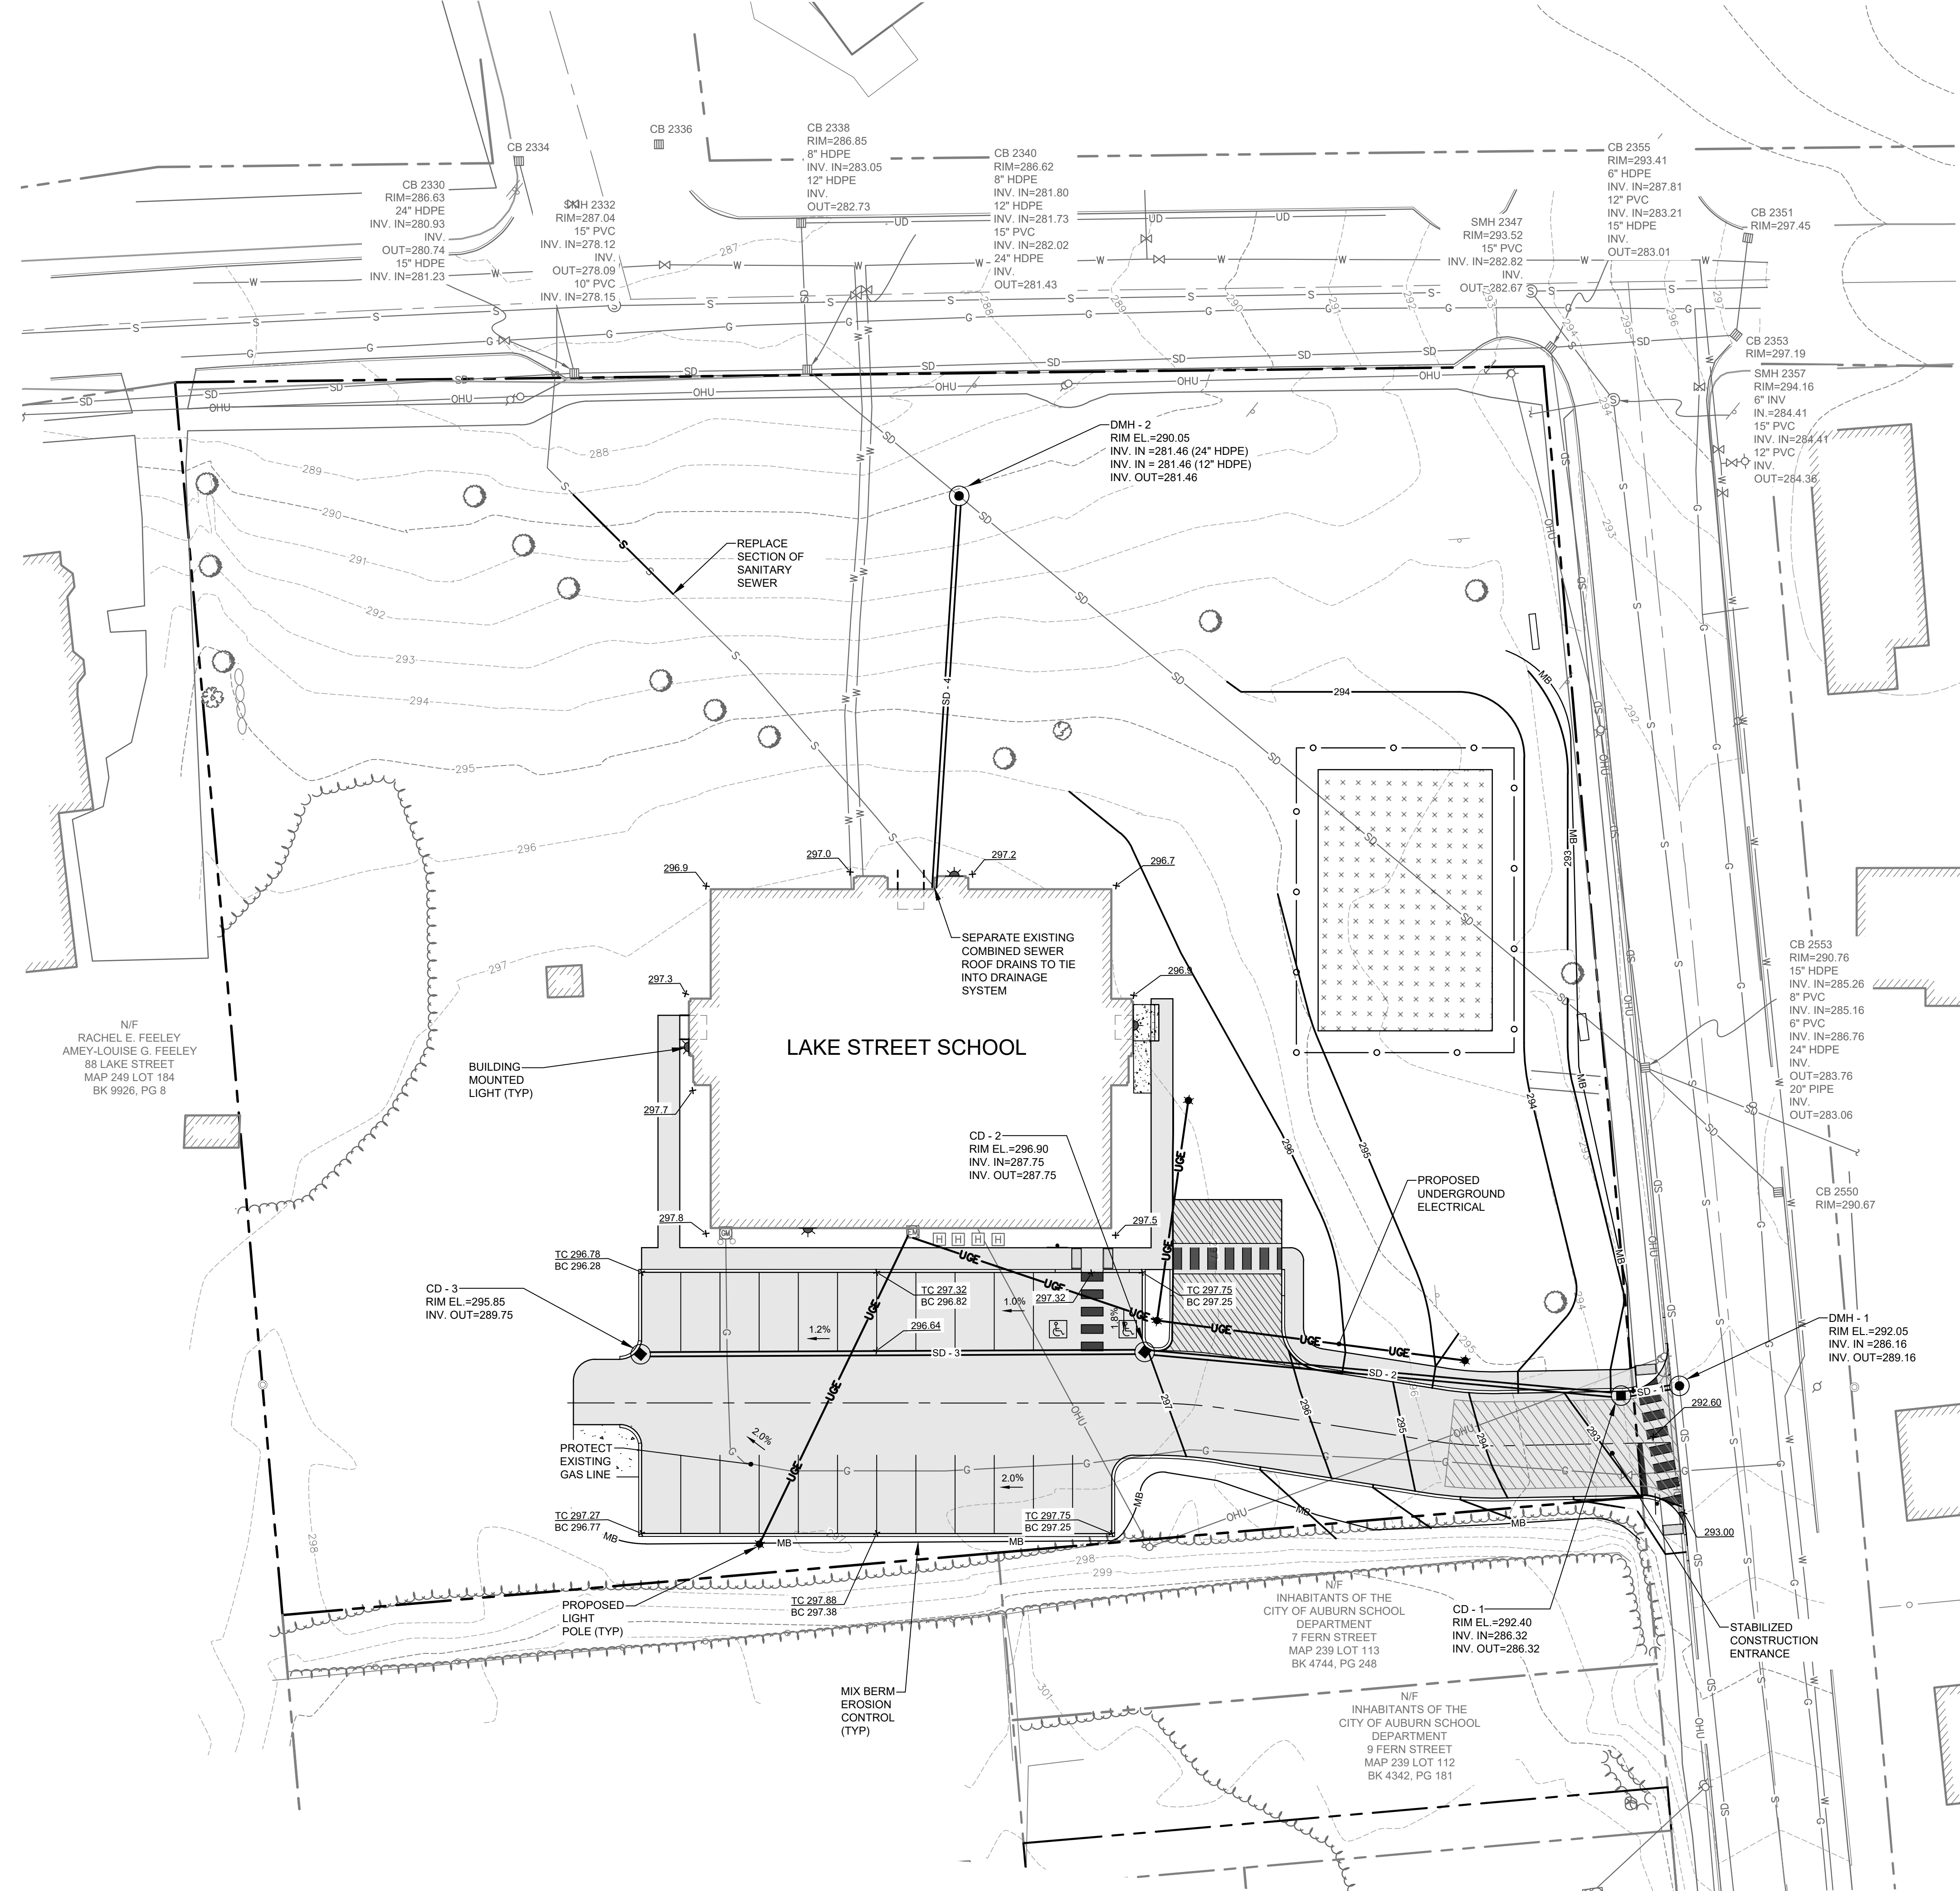
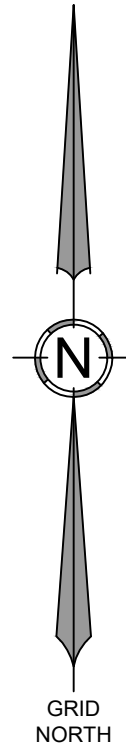


PERMIT DRAWING  
NOT FOR CONSTRUCTION

PROJECT: LAKE STREET SCHOOL APARTMENTS  
80 LAKE STREET, AUBURN, MAINE  
SHEET TITLE: SITE LAYOUT PLAN  
CLIENT: JIM WU  
279 CENTER STREET  
AUBURN, MAINE 04210

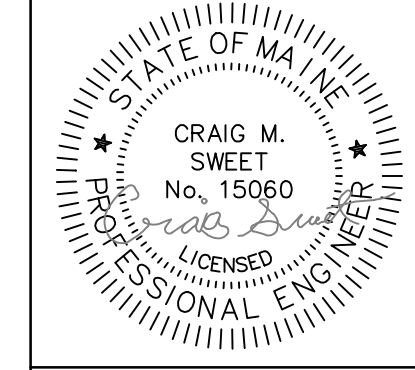
DATE: 4/3/2024  
SCALE: 1"=20'  
JOB NO: 23-75  
SHEET: C-2.0





**STORM DRAIN PIPE DATA**

NAME	SIZE	LENGTH	SLOPE
SD - 1	12"	14'	1.18%
SD - 2	12"	110'	1.30%
SD - 3	12"	116'	1.73%
SD - 4	12"	90'	1.71%



DATE: 4/3/2024

NO.	DATE	REVISIONS
1	5/3/2024	FIRE TRUCK ACCESS & PLAYGROUND EASEMENT

NO.	DATE	REVISIONS
1	5/3/2024	FIRE TRUCK ACCESS & PLAYGROUND EASEMENT

ADDRESS: 41 CAMPUS DRIVE, SUITE 301  
NEW GLOUCESTER, ME 04280  
PHONE: (207) 926-5111  
WEB SITE: www.terradynconsultants.com

**TERRADYN CONSULTANTS, LLC**  
Civil Engineering | Land Surveying | Geomatics  
Stormwater Design | Land Planning | Environmental Permitting

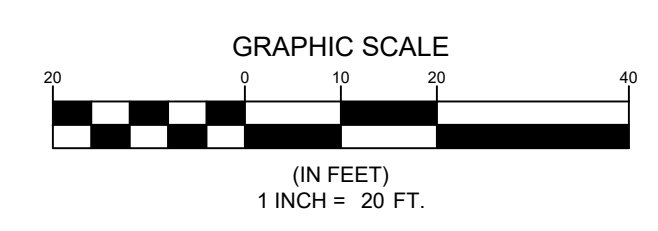
PERMIT DRAWING  
NOT FOR CONSTRUCTION

PROJECT: LAKE STREET SCHOOL APARTMENTS  
80 LAKE STREET, AUBURN, MAINE

SHEET TITLE: GRADING & UTILITY PLAN

CLIENT: JIM WU  
279 CENTER STREET  
AUBURN, MAINE 04210

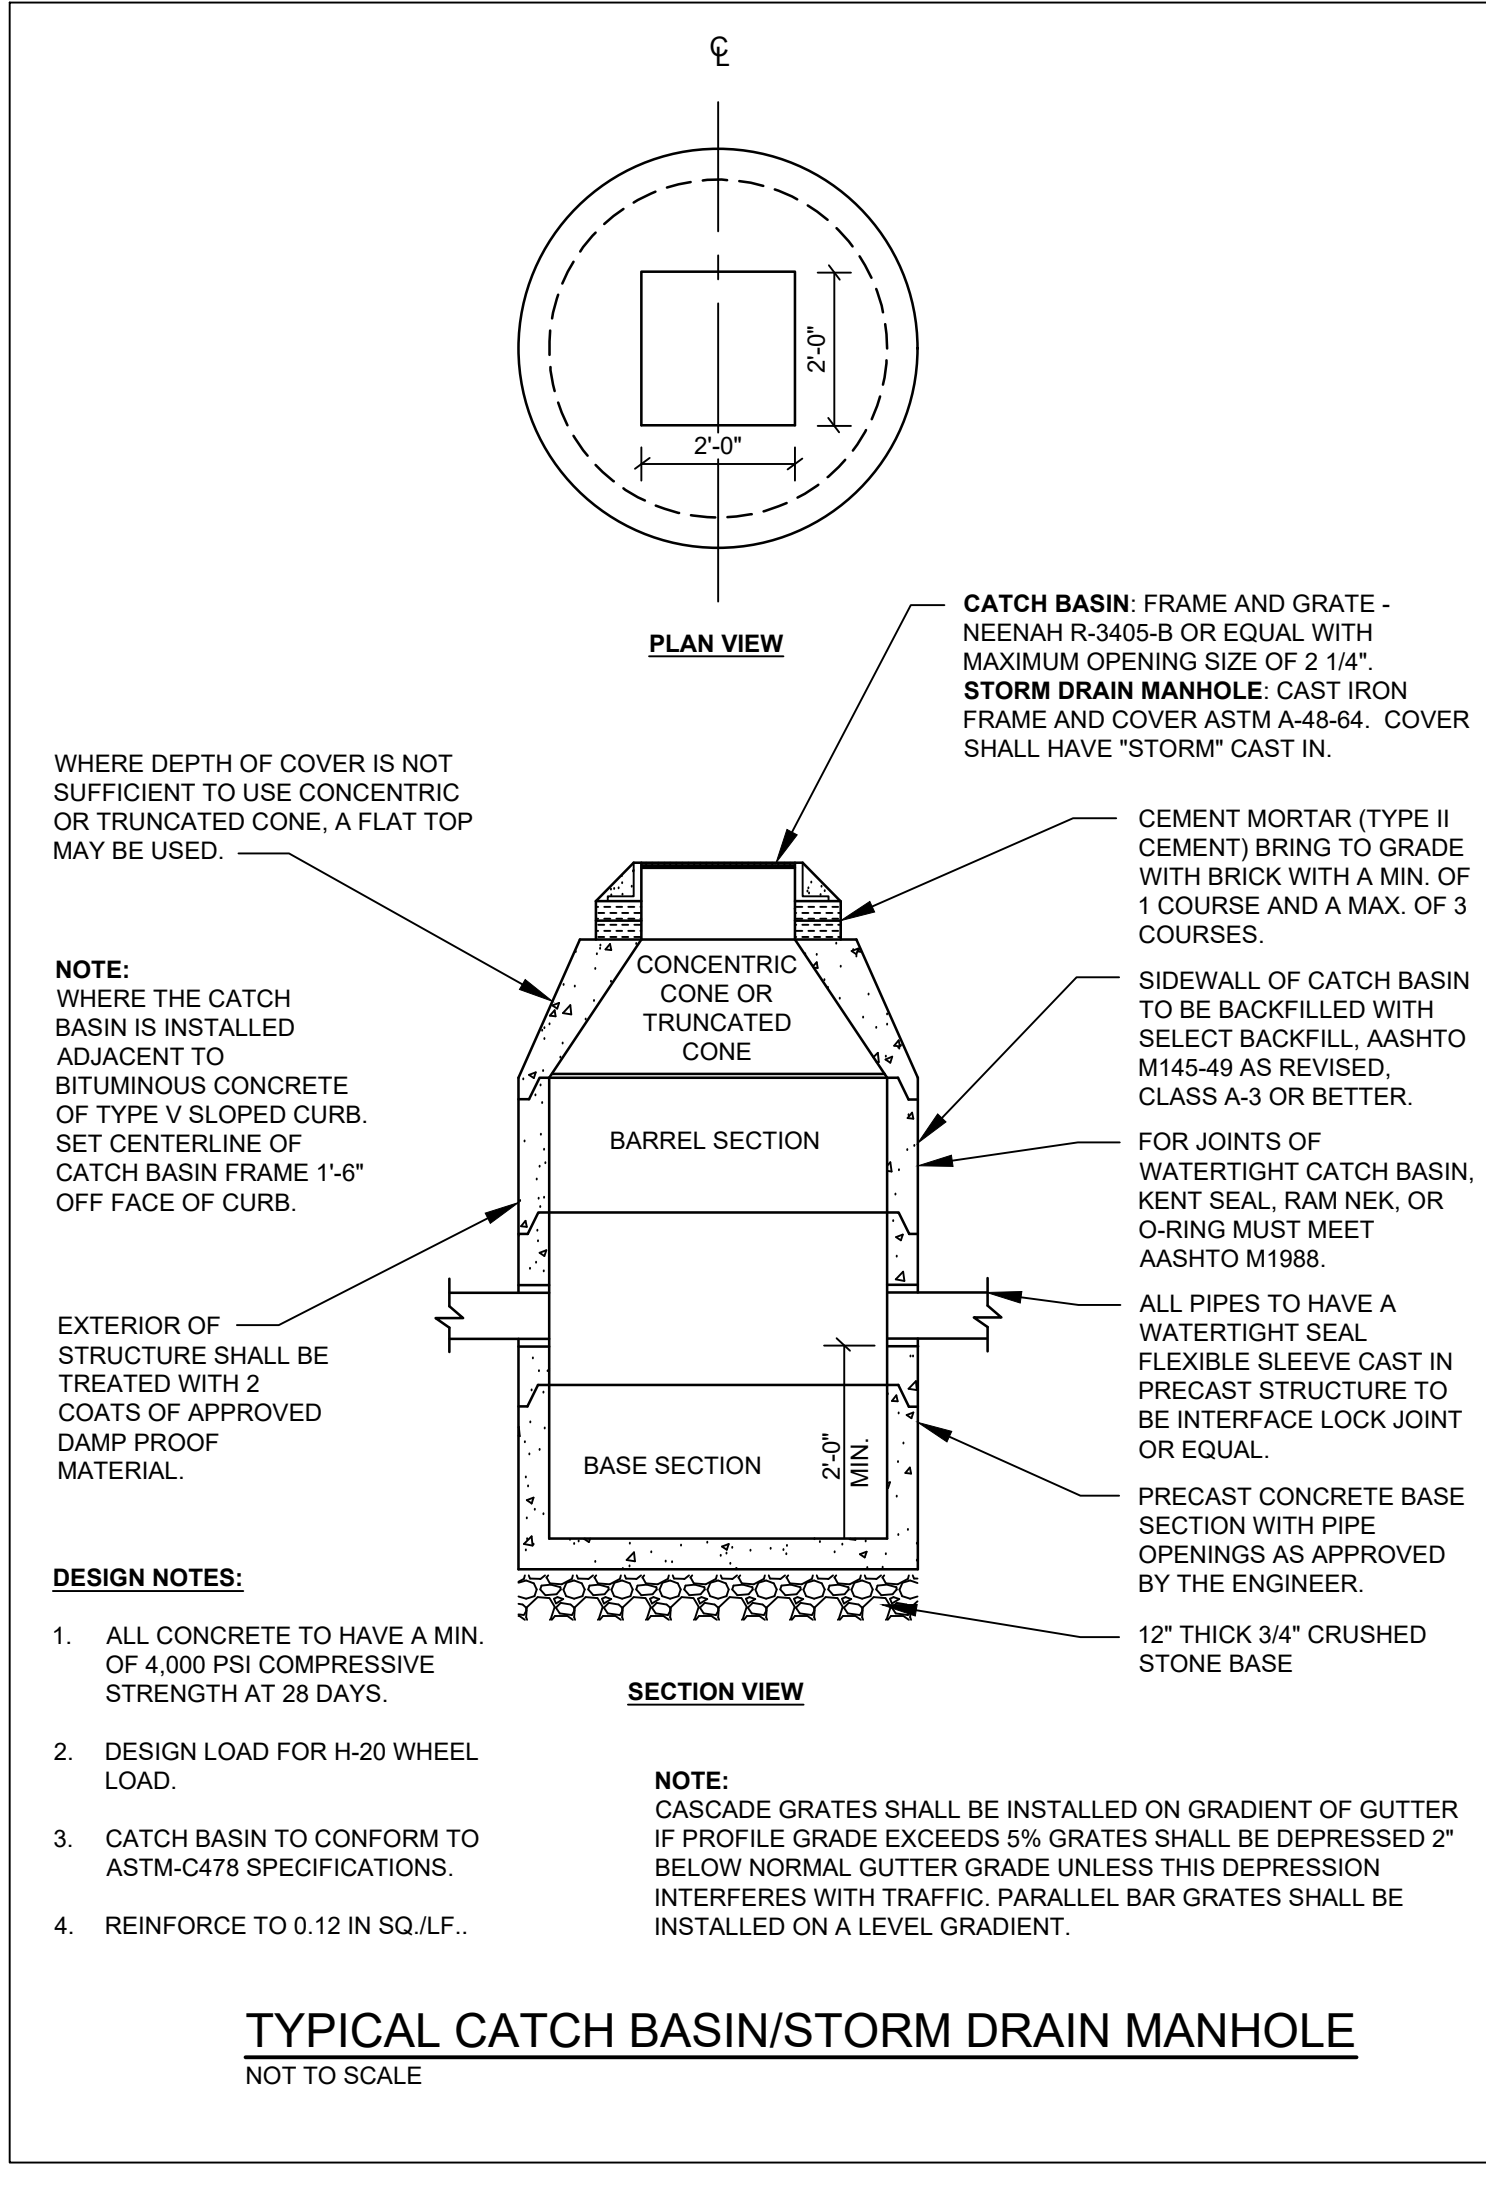
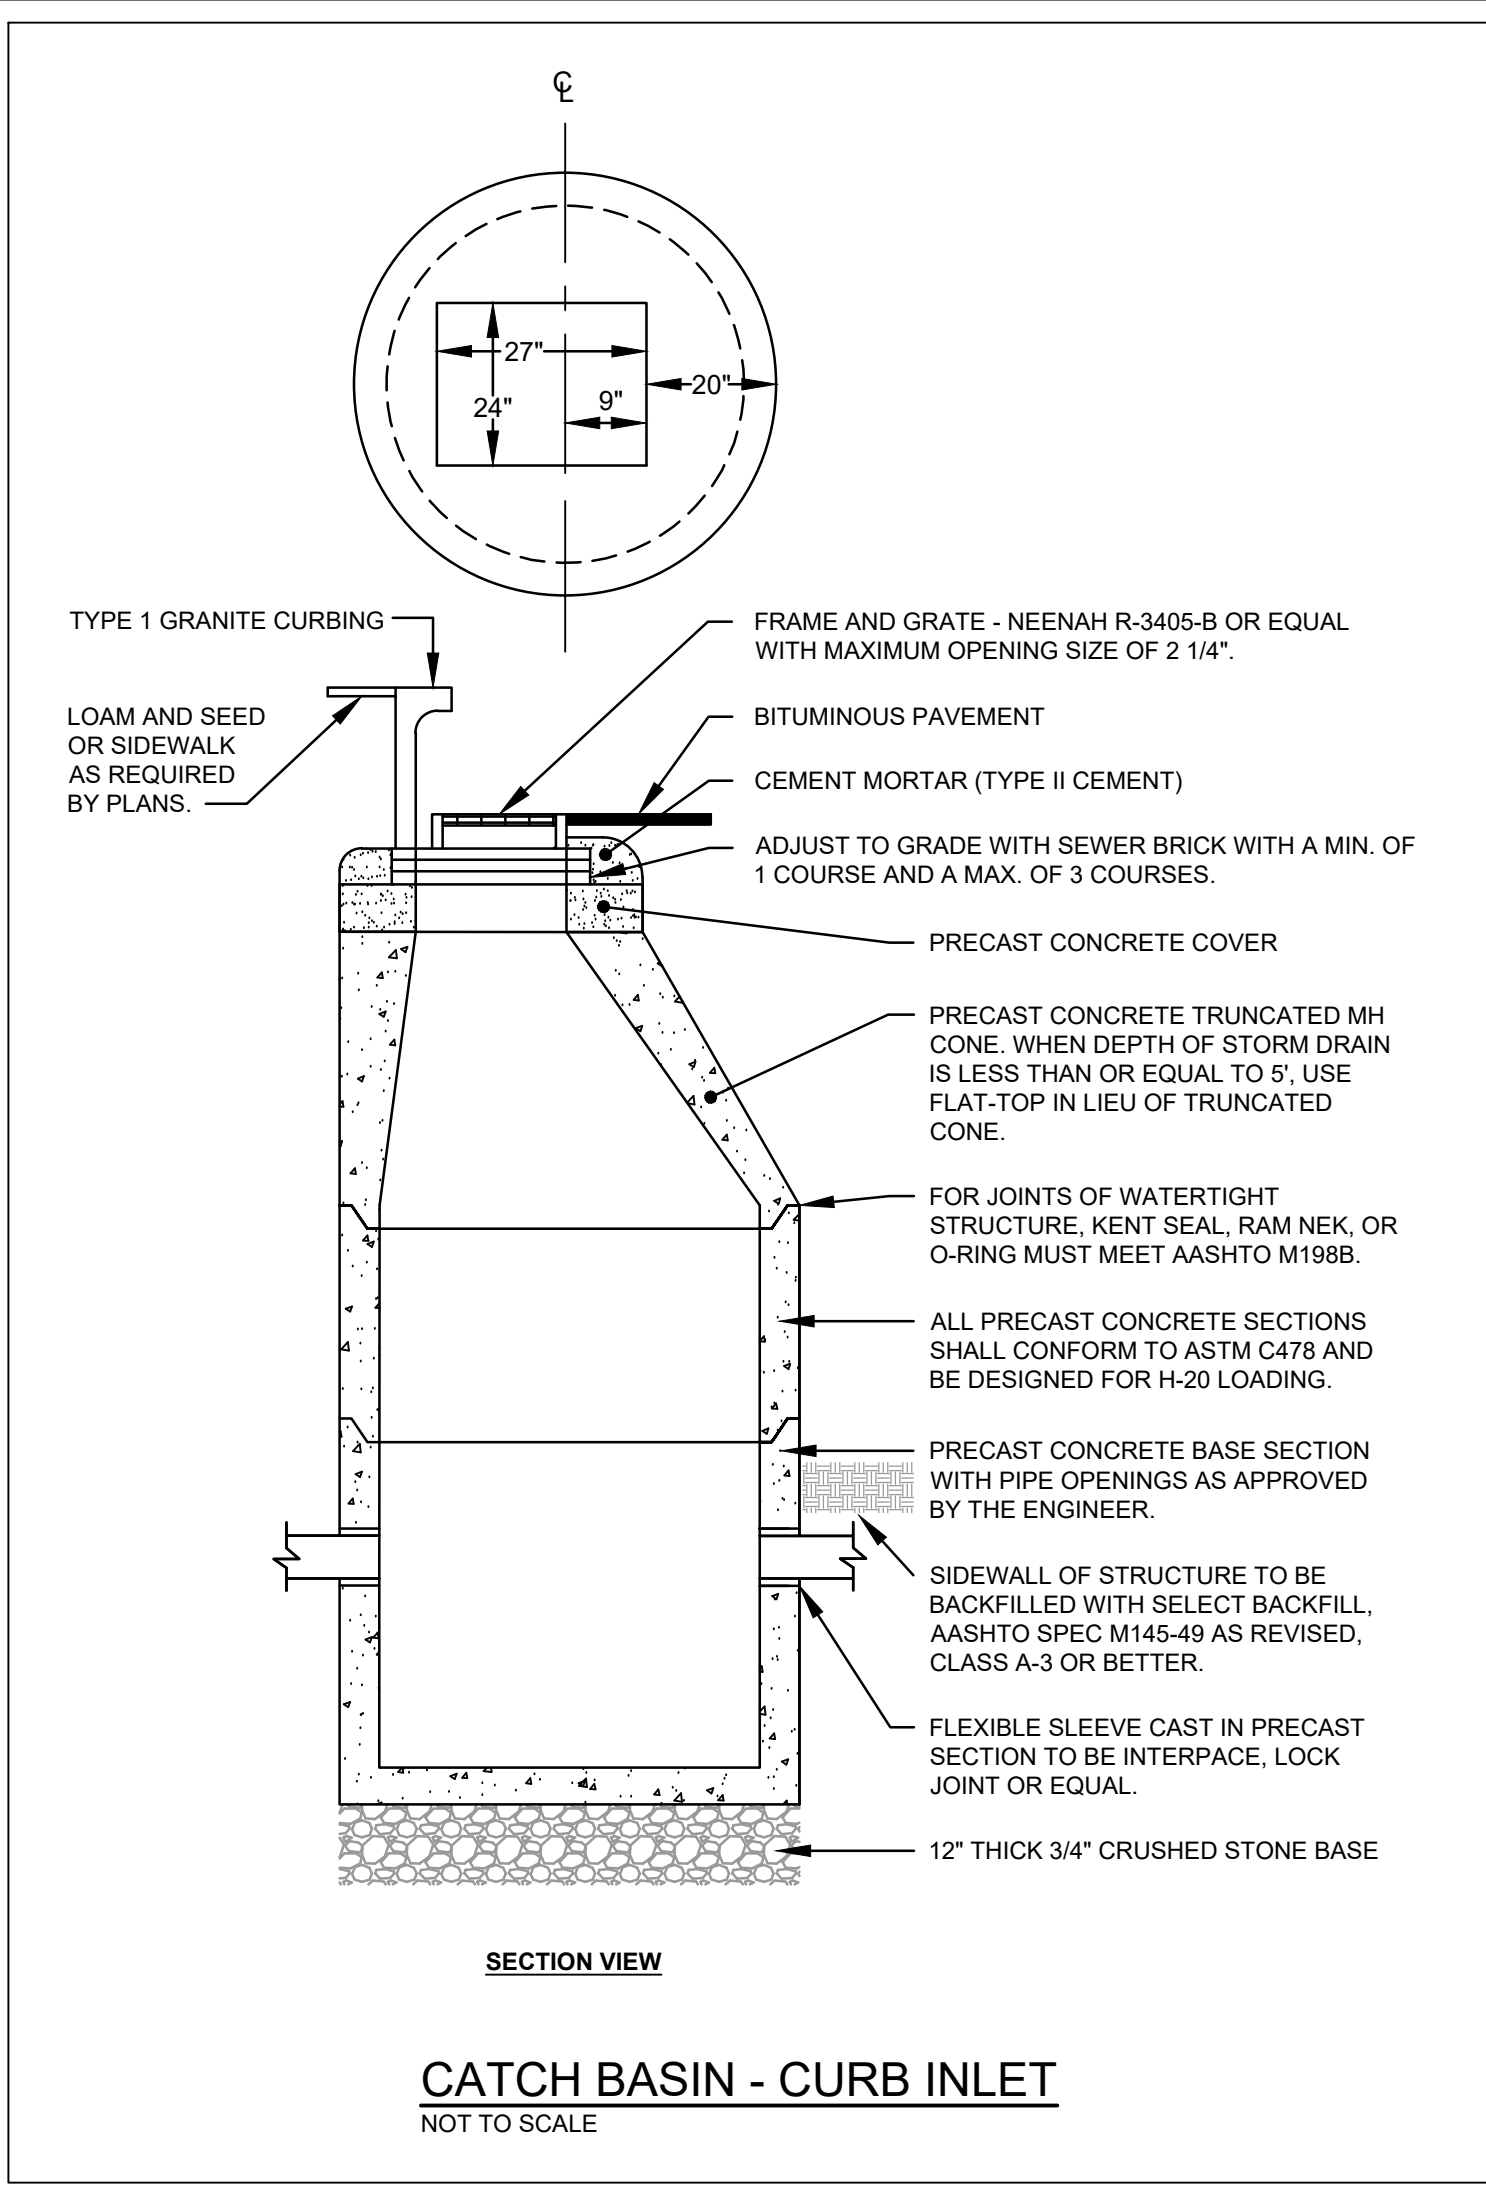
DATE: 4/3/2024  
SCALE: 1"=20'  
JOB NO.: 23-75  
SHEET: C-3.0



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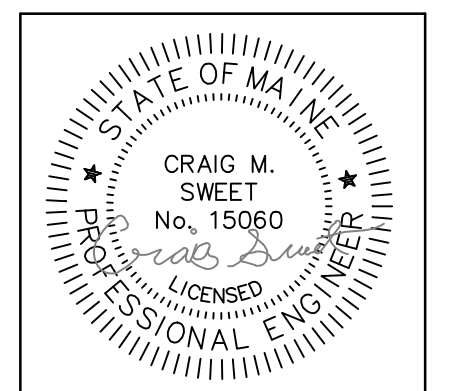


**CONSTRUCTION NOTES**

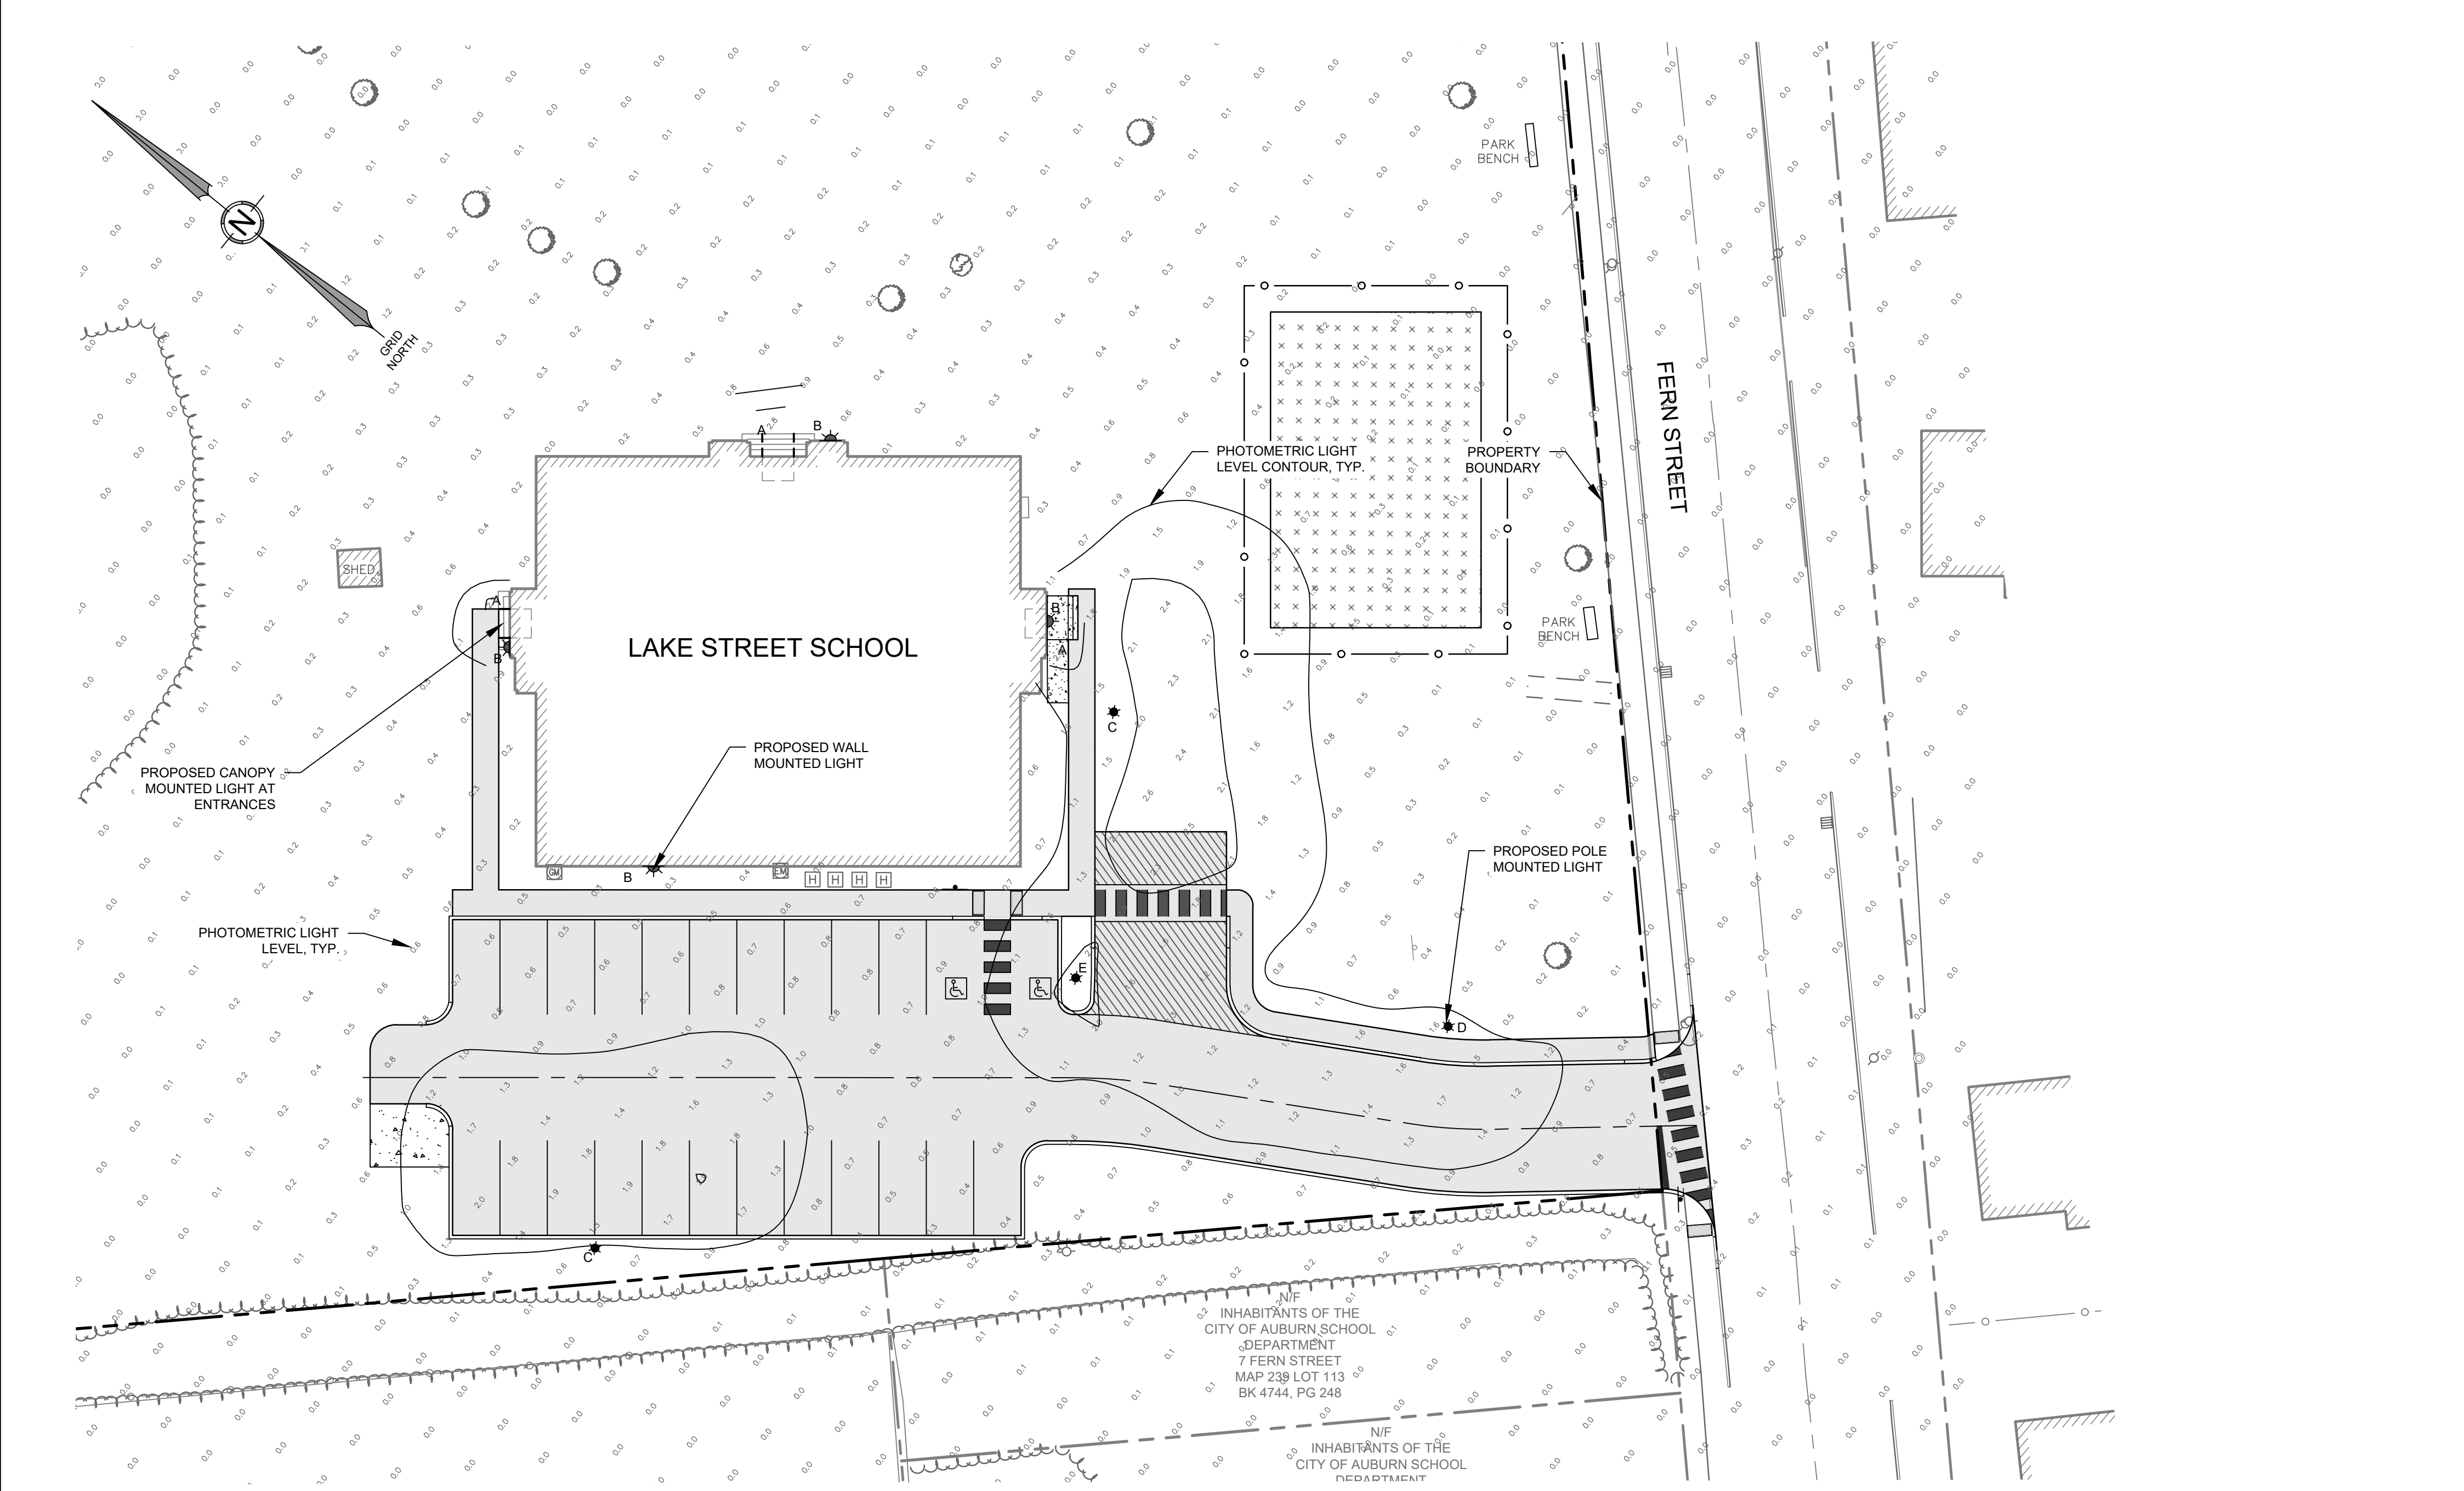
1. ALL WORK SHALL CONFORM TO THE APPLICABLE CODES AND ORDINANCES.
2. CONTRACTOR SHALL VISIT THE SITE AND FAMILIARIZE HIM OR HERSELF WITH ALL CONDITIONS AFFECTING THE PROPOSED WORK AND SHALL MAKE PROVISIONS AS TO THE COST THEREOF. CONTRACTOR SHALL BE RESPONSIBLE FOR FAMILIARIZING HIM OR HERSELF WITH ALL CONTRACT DOCUMENTS, FIELD CONDITIONS AND DIMENSIONS AND CONFIRMING THAT THE WORK MAY BE ACCOMPLISHED AS SHOWN PRIOR TO PROCEEDING WITH CONSTRUCTION. ANY DISCREPANCIES SHALL BE BROUGHT TO THE ATTENTION OF THE ENGINEER PRIOR TO THE COMMENCEMENT OF WORK.
3. CONTRACTOR SHALL NOTIFY ENGINEER OF ALL PRODUCTS OR ITEMS NOTED AS "EXISTING" WHICH ARE NOT FOUND IN THE FIELD.
4. INSTALL ALL EQUIPMENT AND MATERIALS IN ACCORDANCE WITH MANUFACTURER'S RECOMMENDATIONS AND OWNER'S REQUIREMENTS UNLESS SPECIFICALLY OTHERWISE INDICATED OR WHERE LOCAL CODES OR REGULATIONS TAKE PRECEDENCE.
5. CONTRACTOR SHALL VERIFY ALL DIMENSIONS AND CONDITIONS IN THE FIELD PRIOR TO FABRICATION AND ERECTION OF ANY MATERIAL. ANY UNUSUAL CONDITIONS SHALL BE REPORTED TO THE ATTENTION OF THE ENGINEER.
6. CONTRACTOR SHALL CLEAN AND REMOVE DEBRIS AND SEDIMENT DEPOSITED ON PUBLIC STREETS, SIDEWALKS, ADJACENT AREAS, OR OTHER PUBLIC WAYS DUE TO CONSTRUCTION.
7. CONTRACTOR SHALL INCORPORATE PROVISIONS AS NECESSARY IN CONSTRUCTION TO PROTECT EXISTING STRUCTURES, PHYSICAL FEATURES, AND MAINTAIN SITE STABILITY DURING CONSTRUCTION. CONTRACTOR SHALL RESTORE ALL AREAS TO ORIGINAL CONDITION AND AS DIRECTED BY DESIGN DRAWINGS.
8. SITE CONTRACTOR SHALL OBTAIN ALL REQUIRED PERMITS PRIOR TO CONSTRUCTION.
9. ALL EROSION AND SEDIMENT CONTROL MEASURES SHALL BE INSTALLED IN ACCORDANCE WITH "MAINE EROSION AND SEDIMENTATION CONTROL HANDBOOK FOR CONSTRUCTION: BEST MANAGEMENT PRACTICES" PUBLISHED BY THE CUMBERLAND COUNTY SOIL AND WATER CONSERVATION DISTRICT AND MAINE DEPARTMENT OF ENVIRONMENTAL PROTECTION, MARCH 2016 OR LATEST EDITION. IT SHALL BE THE RESPONSIBILITY OF THE CONTRACTOR TO POSSESS A COPY OF THE EROSION CONTROL PLAN AT ALL TIMES.
10. THE CONTRACTOR IS HEREBY CAUTIONED THAT ALL SITE FEATURES SHOWN HEREON ARE BASED ON FIELD OBSERVATIONS BY THE SURVEYOR AND BY INFORMATION PROVIDED BY UTILITY COMPANIES. THE INFORMATION IS NOT TO BE RELIED ON AS BEING EXIST OR COMPLETE. THE CONTRACTOR SHALL CONTACT DIG SAFE (1-888-DIGSAFE) AT LEAST THREE (3) BUT NOT MORE THAN THIRTY (30) DAYS PRIOR TO COMMENCEMENT OF EXCAVATION OR DEMOLITION TO VERIFY HORIZONTAL AND VERTICAL LOCATION OF ALL UTILITIES.
11. CONTRACTOR SHALL BE AWARE THAT DIG SAFE ONLY NOTIFIES ITS "MEMBER" UTILITIES ABOUT THE DIG. WHEN NOTIFIED, DIG SAFE WILL ADVISE CONTRACTOR OF MEMBER UTILITIES IN THE AREA. CONTRACTOR IS RESPONSIBLE FOR IDENTIFYING AND CONTACTING NON-MEMBER UTILITIES DIRECTLY. NON-MEMBER UTILITIES MAY INCLUDE TOWN OR CITY WATER AND SEWER DISTRICTS AND SMALL LOCAL UTILITIES, AS WELL AS USG PUBLIC WORKS SYSTEMS.
12. CONTRACTORS SHALL BE RESPONSIBLE FOR COMPLIANCE WITH THE REQUIREMENTS OF 23 MRSA 3360-A. IT SHALL BE THE RESPONSIBILITY OF THE CONTRACTOR TO COORDINATE WITH THE APPROPRIATE UTILITIES TO OBTAIN AUTHORIZATION PRIOR TO RELOCATION OF ANY EXISTING UTILITIES WHICH CONFLICT WITH THE PROPOSED IMPROVEMENTS SHOWN ON THESE PLANS. IF A UTILITY CONFLICT ARISES, THE CONTRACTOR SHALL IMMEDIATELY NOTIFY THE OWNER, THE MUNICIPALITY AND APPROPRIATE UTILITY COMPANY PRIOR TO PROCEEDING WITH ANY RELOCATION.
13. ALL PAVEMENT MARKINGS AND DIRECTIONAL SIGNAGE SHOWN ON THE PLAN SHALL CONFORM TO THE MANUAL OF UNIFORM TRAFFIC CONTROL DEVICES (MUTCD) STANDARDS.
14. ALL PAVEMENT JOINTS SHALL BE SAWCUT PRIOR TO PAVING TO PROVIDE A DURABLE AND UNIFORM JOINT.
15. NO HOLES, TRENCHES OR STRUCTURES SHALL BE LEFT OPEN OVERNIGHT IN ANY EXCAVATION ACCESSIBLE TO THE PUBLIC OR IN PUBLIC RIGHTS-OF-WAY.
16. ALL WORK WITHIN THE PUBLIC RIGHT-OF-WAY SHALL REQUIRE A M.D.O.T. PERMIT AS WELL AS PERMITS FROM THE TOWN AS APPLICABLE.
17. THE PROPOSED LIMITS OF CLEARING SHOWN HEREON ARE APPROXIMATE BASED UPON THE PROPOSED LIMITS OF SITE GRADING. THE APPLICANT RESERVES THE RIGHT TO PERFORM NORMAL FOREST MANAGEMENT ACTIVITIES OUTSIDE OF THE CLEARING LIMIT AS SHOWN. TREE REMOVAL OUTSIDE OF THE LIMITS OF CLEARING MAY BE NECESSARY TO REMOVE DEAD OR DYING TREES OR TREE LIMBS. THIS REMOVAL IS DUE TO POTENTIAL SAFETY HAZARDS AND TO PROMOTE PROPER FOREST GROWTH.
18. IMMEDIATELY UPON COMPLETION OF CUTS/FILLS, THE CONTRACTOR SHALL STABILIZE DISTURBED AREAS IN ACCORDANCE WITH EROSION CONTROL NOTES AND AS SPECIFIED ON PLANS.
19. THE CONTRACTOR SHALL BE FULLY AND SOLELY RESPONSIBLE FOR THE REMOVAL, REPLACEMENT AND RECTIFICATION OF ALL DAMAGED AND DEFECTIVE MATERIAL AND WORKMANSHIP IN CONNECTION WITH THE CONTRACT WORK. THE CONTRACTOR SHALL REPLACE OR REPAIR AS DIRECTED BY THE OWNER ALL SUCH DAMAGED OR DEFECTIVE MATERIALS WHICH APPEAR WITHIN A PERIOD OF ONE YEAR FROM THE DATE OF SUBSTANTIAL COMPLETION.
20. ALL WORK PERFORMED BY THE GENERAL CONTRACTOR AND/OR TRADE SUBCONTRACTOR SHALL CONFORM TO THE REQUIREMENTS OF LOCAL, STATE OR FEDERAL LAWS, AS WELL AS ANY OTHER GOVERNING REQUIREMENTS, WHETHER OR NOT SPECIFIED ON THE DRAWINGS.
21. WHERE THE TERMS "APPROVED EQUAL", "OTHER APPROVED", "EQUAL TO", "ACCEPTABLE" OR OTHER GENERAL QUALIFYING TERMS ARE USED IN THESE NOTES, IT SHALL BE UNDERSTOOD THAT REFERENCE IS MADE TO THE RULING AND JUDGMENT OF TERRADYN CONSULTANTS, LLC.
22. THE GENERAL CONTRACTOR SHALL PROVIDE ALL NECESSARY PROTECTION FOR THE WORK UNTIL TURNED OVER TO THE OWNER.
23. THE GENERAL CONTRACTOR SHALL MAINTAIN A CURRENT AND COMPLETE SET OF CONSTRUCTION DRAWINGS ON SITE DURING ALL PHASES OF CONSTRUCTION FOR USE OF ALL TRADES.
24. THE CONTRACTOR SHALL TAKE FULL RESPONSIBILITY FOR ANY CHANGES AND DEVIATION OF APPROVED PLANS NOT AUTHORIZED BY THE ARCHITECT/ENGINEER AND/OR CLIENT/OWNER.
25. DETAILS ARE INTENDED TO SHOW END RESULT OF DESIGN. ANY MODIFICATION TO SUIT FIELD DIMENSION AND CONDITION SHALL BE SUBMITTED TO THE ENGINEER FOR REVIEW AND APPROVAL PRIOR TO ANY WORK.
26. BEFORE THE FINAL ACCEPTANCE OF THE PROJECT, THE CONTRACTOR SHALL REMOVE ALL EQUIPMENT AND MATERIALS, REPAIR OR REPLACE PRIVATE OR PUBLIC PROPERTY WHICH MAY HAVE BEEN DAMAGED OR DESTROYED DURING CONSTRUCTION. CLEAN THE AREAS WITHIN AND ADJACENT TO THE PROJECT WHICH HAVE BEEN OBSTRUCTED BY HIS/HER OPERATIONS, AND LEAVE THE PROJECT AREA NEAT AND PRESENTABLE.

**HOUSEKEEPING NOTES:**

1. SPILL PREVENTION, CONTROLS MUST BE USED TO PREVENT POLLUTANTS FROM BEING DISCHARGED FROM MATERIALS ON SITE, INCLUDING STORAGE PRACTICES TO MINIMIZE EXPOSURE OF THE MATERIALS TO STORMWATER, AND APPROPRIATE SPILL PREVENTION, CONTAINMENT, AND RESPONSE PLANNING AND IMPLEMENTATION.
2. GROUNDWATER PROTECTION. DURING CONSTRUCTION, LIQUID PETROLEUM PRODUCTS AND OTHER HAZARDOUS MATERIALS WITH THE POTENTIAL TO CONTAMINATE GROUNDWATER MAY NOT BE STORED OR HANDLED IN AREAS OF THE SITE DRAINING TO AN INFILTRATION AREA. AN "INFILTRATION AREA" IS ANY AREA OF THE SITE THAT BY DESIGN OR AS A RESULT OF SOILS, TOPOGRAPHY AND OTHER RELEVANT FACTORS ACCUMULATES RUNOFF THAT INFILTRATES INTO THE SOIL. DIKES, BERMES, SUMPS, AND OTHER FORMS OF SECONDARY CONTAINMENT THAT PREVENT DISCHARGE TO GROUNDWATER MAY BE USED TO ISOLATE PORTIONS OF THE SITE FOR THE PURPOSES OF STORAGE AND HANDLING OF THESE MATERIALS.
3. FUGITIVE SEDIMENT AND DUST. ACTIONS MUST BE TAKEN TO ENSURE THAT ACTIVITIES DO NOT RESULT IN NOTICEABLE EROSION OF SOILS OR FUGITIVE DUST EMISSIONS DURING OR AFTER CONSTRUCTION. OIL MAY NOT BE USED FOR DUST CONTROL.
4. DEBRIS AND OTHER MATERIALS, LITTER, CONSTRUCTION DEBRIS, AND CHEMICALS EXPOSED TO STORMWATER MUST BE PREVENTED FROM BECOMING A POLLUTANT SOURCE.
5. TRENCH OR FOUNDATION DE-WATERING. TRENCH DE-WATERING IS THE REMOVAL OF WATER FROM TRENCHES, FOUNDATIONS, COFFER DAMS, PONDS, AND OTHER AREAS WITHIN THE CONSTRUCTION AREA THAT RETAIN WATER AFTER EXCAVATION. IN MOST CASES THE COLLECTED WATER IS HEAVILY SILTED AND HINDERS CORRECT AND SAFE CONSTRUCTION PRACTICES. THE COLLECTED WATER MUST BE REMOVED FROM THE PONDED AREA, EITHER THROUGH GRAVITY OR PUMPING, AND MUST BE SPREAD THROUGH NATURAL WOODED BUFFERS OR REMOVED TO AREAS THAT ARE SPECIFICALLY DESIGNED TO COLLECT THE MAXIMUM AMOUNT OF SEDIMENT POSSIBLE, LIKE A COFFERDAM SEDIMENTATION BASIN. AVOID ALLOWING THE WATER TO FLOW OVER DISTURBED AREAS OF THE SITE. EQUIVALENT MEASURES MAY BE TAKEN IF APPROVED BY THE DEPARTMENT.
6. NON-STORMWATER DISCHARGES. IDENTIFY AND PREVENT CONTAMINATION BY NON-STORMWATER DISCHARGES.
7. ADDITIONAL REQUIREMENTS. ADDITIONAL REQUIREMENTS MAY BE APPLIED ON A SITE-SPECIFIC BASIS.

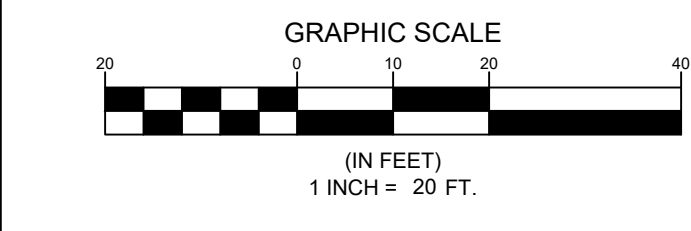


DATE: 4/3/2024	
1	5/3/2024
NO.	DATE
FIRE TRUCK ACCESS & PLAYGROUND EASEMENT REVISIONS	
ADDRESS: 47 CAMPUS DRIVE, SUITE 301, NEW GLOUCESTER, ME 04860	
PHONE: (207) 828-5111	
WEB SITE: www.terradynconsultants.com	
TERRADYN CONSULTANTS, LLC	
Civil Engineering   Land Surveying   Geomatics	
Stormwater Design   Land Planning   Environmental Permitting	
PERMIT DRAWING NOT FOR CONSTRUCTION	
PROJECT: LAKE STREET SCHOOL APARTMENTS	
SHEET TITLE: SITE DETAILS & NOTES	
CLIENT: JIM WU	
279 CENTER STREET, AUBURN, MAINE 04210	
DATE:	4/3/2024
SCALE:	AS NOTED
JOB NO:	23-75
SHEET:	C-4.2



LABEL	LIGHT FIXTURE	MANUFACTURER	MANUFACTURERS ID	LUMENS	NUMBER OF LIGHTS	MOUNTING HEIGHT	MOUNTING LOCATION
A	CANOPY	LOTUS LED LIGHTS	LLL-LD1535TR	900	3	12'	CANOPY
B	WALL LIGHT	BEACON	RWL1-48L-20-3K7-3	2,500	4	28'	WALL
C	VIPER AREA/SITE	CURRENT	VP-1-160L-50-3K7-4W-HSS-90-B	7,500	2	20'	POLE
D	VIPER AREA/SITE	CURRENT	VP-ST-1-36L-39-3K7-3	5,028	1	20'	POLE
E	VIPER AREA/SITE	CURRENT	VP-1-160L-50-3K7-5QW	7,500	1	20'	POLE

STANDARD	PROVIDED VALUE
PROPOSED TIME OF USE	DUSK TO DAWN



### LL4RR

#### 4" Round Regressed 2nd Gen Plenum 14.5W

Project: 405 CENTER STREET APARTMENTS  
Location: AUBURN, ME

Model #: \_\_\_\_\_ Qty: \_\_\_\_\_

Notes: \_\_\_\_\_

SPECIFICATION	
Applications	Recessed Ceiling Mount
Energy Used	14.5 W
Color Temperature (K)	2700 ( 3000 ) 4000   Dim to Warm 3000-1800K
Light Output (lm)	950   1000 ( 1020 ) 900
Halogen Equivalent	90 W
Beam Angle	90°
CRI	90+
Default Driver Input	120V AC Triac Dimmable
Optional Driver Input	120V-347V AC 0-10V Dimmable
Junction Box Wire Capacity	Max 5 No 12 AWG or 8 No 14 AWG
Power Factor	0.98
Approved Location	Insulated Ceilings, Open Plenum, Wet
IP Rating	IP 54
Air Tight	Yes
Ambient Temperature	-40°F (-40°C) to +104°F (+40°C)
Projected Life	70% Light Output at 50,000 Hours
Certification	cULus, Energy Star (except DTW)
Warranty	10 Year Residential / 5 Year Commercial

DESCRIPTION  
4" Round Recessed LED With Integral Driver In Connection Box  
Commercial Grade Quality With Architectural Design

FEATURES & BENEFITS  
2" Deep - Install Where Ceiling Space Is Limited  
Type IC Rated - No Housing Required  
CRI 90+ for True Color Rendering  
Fast & Easy To Install - Save On Labor  
Driver Inside Connection Box - No Junction Box Needed  
Armored Cable & Metal Connectors - Open Plenum Rated

MOUNTING  
Cut Hole In Ceiling And Snap Fixture In Opening With Attached Spring Clips. Ceiling Clearance Required: 2"

DIMENSIONS: ID 4" OD 5" Cut Out 4" to 4 1/4"

AVAILABLE TRIMS  
White Black

TO BE COORDINATED WITH FINAL BUILDING COLOR SELECTION

### VIPER Area/Site

VIPER LUMINAIRE

**FEATURES**

- Low profile LED area/site luminaire with a variety of IES distributions for lighting applications such as auto dealership, retail, commercial, and campus parking lots
- Featuring two different optical technologies, Strike and Micro Strike Optics, which provide the best distribution patterns for retrofit or new construction
- Rated for high vibration applications including bridges and overpasses. All sizes are rated for 15G
- Control options including photo control, occupancy sensing, NX Lighting Controls™, LightGRID™ and 7-Pin with networked controls
- New customizable lumen output feature allows for the wattage and lumen output to be customized in the factory to meet whatever specification requirements may entail
- Field interchangeable mounting provides additional flexibility after the fixture has shipped

**CONTROL TECHNOLOGY**  
NX LIGHTGRID™

**SERVICE PROGRAMS**  
STOCK QS10

**SPECIFICATIONS**

**CONSTRUCTION**

- Die-cast housing with hidden vertical heat fins are optimal for heat dissipation while keeping a clean smooth outer surface
- Corrosion resistant, die-cast aluminum housing with 1000 hour powder coat paint finish
- External hardware is corrosion resistant

**OPTICS**

- Micro Strike Optics (60, 72, 108, or 162 LED counts) maximize uniformity in applications and come standard with mid-powered LEDs which evenly illuminate the entire luminous surface area to provide a low glare appearance. Catalog logic found on page 2
- Strike Optics (66, 72, 108, or 162 LED counts) provide best in class distributions and maximum pole spacing in new applications with high powered LEDs. Strike optics are held in place with a polycarbonate bezel to mimic the appearance of the Micro Strike Optics so both solutions can be combined on the same application. Catalog logic found on page 3
- Both optics maximize target zone illumination with minimal losses at the house-side, reducing light trespass issues. Additional backlight control shields and house side shields can be added for further reduction of illumination behind the pole
- One-piece silicone gasket ensures a weatherproof
- Zero up-light at 0 degrees of tilt
- Field replaceable optics

**INSTALLATION**

- All mounting hardware included
- Knuckle arm filter option available for 2-3/8" OD ferron
- Optional universal mounting block for ease of installation during retrofit applications. Available as an option (ASU) or accessory for square and round poles
- For products with EPA less than 1 mounted to a pole greater than 20ft, a vibration damper is recommended

DATE: \_\_\_\_\_ LOCATION: \_\_\_\_\_

TYPE: \_\_\_\_\_ PROJECT: \_\_\_\_\_

CATALOG #: \_\_\_\_\_

**CERTIFICATIONS**

- DLC (DesignLights Consortium) Qualified, with some Premium Qualified configurations. Not all product variations listed in this document are DLC qualified. Refer to <http://www.designlights.org> for the most up-to-date list.
- Listed to UL1998 and CSA C22.2 #250.0-24 for wet locations and 40°C ambient temperatures
- 1.5 G rated for ANSI C136.31 high vibration applications
- Fixture is IP65 rated
- Meets EIA recommendations using 3K CCT configuration at 0 degrees of tilt
- This product meets federal procurement law requirements under the Buy American Act (48 CFR 52.225-9) and Trade Agreements Act (19 USC 2511). See Buy American Solutions (BAS) to <http://www.currentlighting.com/buyamericansolutions>

**WARRANTY**

- 5 year warranty

Page 1 of 8 Rev 1/15/23 BEAUPRSPR\_R08

### RATIO Wall

RWL1/RWL2 LED WALLPACK

**FEATURES**

- Low profile LED wall luminaire with a variety of IES distributions for lighting applications such as retail, commercial and industrial building mount
- Featuring Micro Strike Optics which maximizes target zone illumination with minimal losses at the house-side, reducing light trespass issues
- Visual comfort standard
- Control options including photo control, occupancy sensing, NX Distributed Intelligence™, Wiscapac and 7-Pin with networked controls
- Battery Backup options available for emergency code compliance
- Quick-mount adapter allows easy installation/maintenance
- 347V and 480V versions for industrial applications and Canada

**CONTROL TECHNOLOGY**  
NX LIGHTGRID™

**SERVICE PROGRAM**  
QS10

**SPECIFICATIONS**

**CONSTRUCTION**

- Die-cast housing with hidden vertical heat fins that are optimal for heat dissipation while keeping a clean smooth outer surface
- Corrosion resistant, die-cast aluminum housing with powder coat paint finish
- Powder paint finish provides durability in outdoor environments. Tested to meet 1000 hour salt spray rating

**OPTICS**

- Entire optical aperture illuminates to create a large luminous surface area resulting in a low glare appearance without sacrificing optical performance
- 48 or 160 midpower LEDs
- 3000K, 4000K or 5000K (70 CRI/80 CRI) CCT
- Zero uplight distributions
- LED optics provide IES type II, III and IV distributions. Type II only available in RWL2 configurations

**INSTALLATION**

- Quick-mount adapter provides easy installation to wall or to recessed junction boxes (4" square junction box)
- Designed for direct J-box mount
- Integral back box contains 1/2" conduit hubs
- Integral back box standard with Dual Driver, Dual Power Feed, NX, Wiscapac and battery versions (battery versions for RWL1 only)

**ELECTRICAL**

- 120V-277V universal voltage 50/60Hz 0-10V dimming drivers
- 347V and 480V dimmable driver option for all wattages above 35W
- Ambient operating temperature -40°C to 40°C
- Driver RoHS and IP66

DATE: \_\_\_\_\_ LOCATION: \_\_\_\_\_

TYPE: \_\_\_\_\_ PROJECT: \_\_\_\_\_

CATALOG #: \_\_\_\_\_

**CERTIFICATIONS**

- DLC (DesignLights Consortium) Qualified, with some Premium Qualified configurations. Not all product variations listed in this document are DLC qualified. Refer to <http://www.designlights.org> for the most up-to-date list.
- Listed to UL1998 and CSA C22.2 #250.0-24 for wet locations
- IP65 rated housing
- Not all product variations listed in this document are DLC qualified. Refer to <http://www.designlights.org> for the most up-to-date list.
- Emergency battery backup options are California Energy Commission (CEC) Title 20 Compliant

**WARRANTY**

- 5 year limited warranty

Page 1 of 9 Rev 10/2023 Ratio\_Wall\_Spec\_Sheet\_R04

PROJECT: LAKE STREET SCHOOL APARTMENTS  
80 LAKE STREET, AUBURN, MAINE  
SHEET TITLE: PHOTOMETRIC PLAN  
CLIENT: JIM WU  
279 CENTER STREET  
AUBURN, MAINE 04210

DATE: 4/3/2024  
SCALE: 1" = 20'  
JOB NO: 23-75  
SHEET: C-6.0

ADDRESS: 41 CAMPUS DRIVE, SUITE 301  
NEW GLOUCESTER, ME 04260  
PHONE: (207) 926-5111  
WEB SITE: www.terradynconsultants.com

PERMIT DRAWING NOT FOR CONSTRUCTION

1 9/3/2024 NO DATE

REVISIONS

FIRE TRUCK ACCESS & PLAYGROUND EASEMENT

